

INSTRUCTIONS TO BIDDERS

Date: Feb 5, 2018 BID PACKAGES #: 725-CP1829 & 725-CP1831

1. BID SUBMISSION

The St. Clair Catholic District School Board (Board) is seeking roofing contractors to provide an emergency roof replacement and partial roof replacement at Ursuline College Chatham (UCC) located at 85 Grand Avenue West Chatham Ontario.

Bids from invited bidders shall be submitted on the Bid Form provided and submitted in 2 separate envelopes clearly marked:

Bid Packages #: 725-CP1829 UCC – Emergency Roof Replacement Tender - AREA 'S' 725-CP1831 UCC – Partial Roof Replacement Tender AREA 'K' and 'P'

The envelopes shall be sealed and delivered to: St. Clair Catholic District School Board

420 Creek St Wallaceburg, ON N8A 4C4

Attention: Mr. Tony Prizio, Procurement Specialist

Bids will be accepted not later than

725-CP1829 UCC - Emergency Roof Replacement Tender - AREA 'S'

Feb. 13, 2018 @ 2:00:00 p.m. (No extensions to Bid Closing date are anticipated. Bidders are encouraged to act immediately to prepare their submissions!)

725-CP1831 UCC - Partial Roof Replacement Tender AREA 'K' and 'P'

Feb. 13, 2018 @ 2:30:00 p.m. (No extensions to Bid Closing date are anticipated. Bidders are encouraged to act immediately to prepare their submissions!)

Bids shall be filled out in ink or typed, signed in longhand by a duly authorized company official (having authority to bind). One original of the fully completed Tender Form must be submitted. **Failure to provide all of the requested information on the Tender Form may result in disqualification of the bid**.

Bids by telephone, fax or email will **not** be accepted.

After bid closing, sealed envelopes will be opened by a member of the Boards Purchasing Department and a representative from Corporate Services' department.

2. SCOPE OF WORK

The Instructions to Bidders identifies the work to be performed in the Contract and takes priority if there is a conflict within the Bid Documents. Refer to attached specifications for detailed description of work to be carried out by the successful proponent.

3. BID DOCUMENTS

The following Bid Documents form the basis of this Bid Package and shall be examined by bidders:

- 3.1 Instructions to Bidders dated Feb. 5th, 2018
- 3.2 Tender Form, Specifications and Drawings Ursuline College Chatham School Feb., 2018



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3.3 Prime Contract – Board will issue separate purchase orders to the successful proponent(s). The Board assumes no responsibility for the bidder's failure to examine <u>all</u> of the Bid Documents

4. BID ACCEPTANCE

It shall be understood by all bidders, that the bid shall be valid and subject to acceptance by the Board, and that no adjustments shall be made to the Bid amounts for a period of up to and including sixty (60) days from the Bid Closing Date.

The Board reserves the right to determine the successful bidder by any combination of base bid, separate prices, requested alternate prices and voluntary alternate prices submitted with the bid. The Board is not obligated to select the bid with the lowest price and may cancel a bid prior to award without liability to any bidder.

The successful bidder shall be required to enter into a formal contract with the Board, which will include the terms and conditions of the Instructions to Bidders, Bid Form, and all other applicable documents.

725-CP1829 UCC – Emergency Roof Replacement Tender - AREA 'S'. Will proceed immediately after award.

725-CP1831 UCC – Partial Roof Replacement Tender AREA 'K' and 'P'. Acceptance of this bid and or award of the contract is subject to the approval of the St. Clair Catholic District School Board.

5. <u>AWARD</u>

The Board has the right to reject any or all bids. The lowest Bid will not necessarily be accepted. The invitation to bid does not constitute an offer by the Contractor to enter into a contract.

6. PAYMENT

The Board shall pay within forty-five (45) days after receipt of the invoices which are received and approved by the Board.

7. TAXES

Include in Bid all Taxes and all other Customs Duties and Excise Taxes which are in force at Bid date as detailed in General Conditions. Harmonized Sales Tax (H.S.T.) is <u>not</u> to be included in the bid. The H.S.T. amount and the Bidder's <u>H.S.T. Registration Number</u> are to be indicated on the Bid Form in the spaces provided.

8. ADDENDA

Bidders finding discrepancies, ambiguities or omissions in the bid documents or having doubt as to the meaning or intent thereof, shall immediately notify the Procurement Specialist who may issue instructions and/or clarifications by Addendum to all Bidders. Bidders may also, during the Bidding Period, be advised by Addendum of any additions, deletions or alterations to bid documents. All such Addenda shall become part of the Bid Documents.



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All questions to be addressed in writing to: Mr. Tony Prizio, Procurement Specialist

St. Clair Catholic District School Board E-mail: tony.prizio@st-clair.net
Copy: victoria.iaccino@st-clair.net

No later than 48 hours prior to bid closing date.

9. CHANGE NOTICES, CHANGE ORDERS

The following fee percentage and overhead charges shall be applied to additional work ordered by the Board:

- For work carried out by the Contractor's own forces 10% Overhead & Profit
- For work involving a subcontractor, the subcontractor may charge a maximum 10% fee. The General Contractor may charge a maximum of 5% in addition to subcontractor's fee.

10. BONDING: REQUIREMENT

On bids exceeding \$ 50,000.00, submit with the Bid an Agreement to Bond for a 50% Performance Bond, and a 50% Labour & Material Payment Bond. Upon request, the successful Bidder will be required to provide the 50% Performance Bond and 50% Labour and Material Payment Bond from a bonding company acceptable to the Board. The cost of the bond is <u>not</u> to be included in the bid sum, the amount of which is to be identified on the Bid Form.

Each bid shall be accompanied by bid security in the form of either:

Certified cheque payable to the "St. Clair Catholic District School Board" in the amount of 10% of the bid price;

OR

Bid bond in the amount of 10% of the bid price naming the Owner as obligee and issued by a surety licensed to conduct surety and insurance business in Canada. The bid bond shall remain valid for a period of sixty (60) days from the Submission Deadline.

11. VOLUNTARY ALTERNATE AND SEPARATE PRICES

The bid amounts are to be based on the bid documents. Where there is any conflict within the bid documents, the bid amount shall include the higher cost alternative. Alternative proposals are encouraged and must be identified in the bid. Submit complete information including any impact on schedule to allow a full evaluation of the proposal including, as applicable, any particulars in which the alternate proposal is at variance with or unable to meet the specifications. Note also any impact on other trades if the alternative is accepted. Alternative proposals may be made without limitation, including for items specified as single sourced.

12. EXAMINATION OF SITE & SITE VISIT

In submitting a bid, it will be assumed that the bidders have carefully examined the site and surrounding properties of the work and have informed themselves as to the existing conditions, access, storage areas and limitations, and have included in the bid price the complete cost of the work contemplated by the drawings and specifications and other bid documents.

A <u>mandatory</u> site visit has been scheduled for Feb. 7, 2018 at 10:30 a.m. Interested parties are to meet at the admin. office of Ursuline College Chatham Secondary School, located at 85 Grand Ave. W. Chatham, On. N7L 1B6.



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Date: Feb 5, 2018 BID PACKAGES #: 725-CP1829 & 725-CP1831

13. TIMING OF PROJECT

725-CP1829 UCC – Emergency Roof Replacement Tender - AREA 'S'

PHASE I Must start February 15th, 2018 and to be completed no later than February 19th, 2018. PHASE II Must start March 9th, 2018 and to be completed no later than March 19th, 2018.

725-CP1831 UCC – Partial Roof Replacement Tender AREA 'K' and 'P' To start **July 3**rd, **2018** and to be completed the work by **August 31**st, **2018**.

14. PROJECT SPECIFIC REQUIREMENTS

Contractor shall provide their own washroom facilities for their employees, board washrooms will be offlimits to the contractor's employees.

Please be advised that the Owner has a No Smoking Requirement on the Owners' property. Contractors are requested to ensure that employees and suppliers are advised of the Requirement. Contractor shall remove rubbish and debris from the site on a daily basis or as directed by the Board. On completion of the work, all debris shall be removed; the floor shall be thoroughly cleaned and swept; the site shall be left in a tidy condition (construction clean). Do not use the Board's equipment or facilities for cleaning or for any reason.

15. <u>INSURANCE</u>

Contractor must maintain, at the Contractor's expense for the entire term of the Contract or as otherwise required, all insurance as set out below:

- The successful Contractor shall provide the Board with proof of insurance for Comprehensive General Liability and Property Damage with a limit of not less than \$2,000,000.00 (two million dollars) inclusive prior to commencing work.
- The successful Contractor shall provide the Board with proof of insurance for Motor Vehicle Public Liability and Property Insurance on all owned and rented equipment with a limit of not less than \$2,000,000.00 (two million dollars) inclusive prior to commencing work.
- The Contractor agrees to indemnify, hold harmless, and defend the Board from and against any and all liability for loss, damage and expense, which the Board may suffer or for which the Board may be held liable by reason of injury (including death) or damage to any property arising out of negligence on the party of the proponent or any of its representatives or employees by way of ownership or operation of an automobile.
- The successful Contractor shall provide the Board with a complete certified copy of all policies.
- The successful Contractor must name the St. Clair Catholic District School Board as additional insured on their insurance policies.

16. WORKPLACE SAFETY INSURANCE BOARD (WSIB)

Contractor must furnish a copy of Workplace Safety and Insurance Board Clearance Certificate of good standing, "Section 748" of the Workplace Safety and Insurance Act with its bid documents.

17. PERMITS

The Board will apply and pay for the building permit. The Contractor shall apply for and include costs for



INSTRUCTIONS TO BIDDERS

Date: Feb 5, 2018 BID PACKAGES #: 725-CP1829 & 725-CP1831

any other permits and approvals required for the completion of their work.

18. MEETINGS

A Post Bid Meeting may be convened and chaired by the Board who will invite Contractor and his major Subcontractors to review the Contract Documents and Bid submitted. This meeting will be prior to the Board issuing a Letter of Intent or Contract. This meeting does not constitute or infer any contract award to the proposed contractor or any other contractor, nor that will the project proceed. During the course of Work, scheduled progress meetings may be required at the call of the Project Leader.

19. **GUARANTEE**

The guarantee shall be as outlined in the specifications starting from after completion of the entire job and acceptance thereof by the Board unless a different period of time is specified with the Board's approval. The Contractor's guarantee shall cover all work under the Contract whether or not any portion or trade has been sublet.

The Contractor agrees to correct promptly, at the Contractor's own expense, defects or deficiencies in the Work which appear prior to and during the period of guarantee, or such longer periods as may be specified for certain products or work.

If the Contractor fails to make any replacements or repairs required hereunder, after notice from the Board and reasonable opportunity to do so, the Board may have such work done at Contractor's expense, including all necessary labour costs in connection therewith. Board shall inform Contractor in advance of the approximate cost of such work to be done by the Board.

20. SCHEDULE

The Contractor will be required to perform the work in accordance with the Schedule dates provided in 13. <u>Timing of Project</u>. Ordering of major and long delivery items shall begin immediately upon successful bidder's receipt of contract award. The Contractor will provide a construction schedule within five (5) days of being awarded the project.

Time is of the essence. Bidders are to include adequate manpower, overtime and shift work necessary to meet or improve the schedule, and to make up any time lost to weather or normal delays. Include travel, room and board costs for out of town workers, shop overtime and other premiums to expedite material and equipment, shipping premiums and any incentive costs required to meet the schedule.

21. CONTRACTED SERVICES PROGRAM

Contractors performing work on Board property must complete the Contracted Services Program. This program has three basic components that <u>must</u> be met before the bid is awarded. Contractors who cannot meet the minimum requirements of this program will not be awarded this tender. Program information can be found on the Board's web site at <u>www.st-clair.net</u> or through the Board contact identified previously in this document.

22. HEALTH and SAFETY

The Occupational Health and Safety Act describes the responsibilities of an employer. The Board requires Contractors to maintain procedures, training, and enforcement so that the responsibilities are



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carried out in the workplace. The Contractor shall abide by and strictly adhere to the regulations and conditions set out and laid down by the most current versions of the Occupational Health and Safety Act. All staff employed or hired by the Contractor and working on the Board's premise MUST be trained in WHMIS in accordance with Occupational Health and Safety Act and Regulations. They MUST adhere to all of the Board's Health and Safety Procedures and Guidelines and to Municipal By-Laws.

Contractor will submit proof of its health and safety program, procedures and training as detailed above upon request by the Board.

The Contractor shall appoint a Competent Person as the Supervisor of this project. The Competent Person shall be as defined in Section 1 of the Occupational Health and Safety Act.

The successful Contractor shall conform to the Ontario "Occupational Health and Safety Act" and all regulations made under said act and assume full responsibility for contraventions of same.

All workplace injuries or accidents on Board property MUST be reported by the Contractor to the Board's representative within 24 hours.

Any workplace injury that is defined under the Occupational Health and Safety Act as a "Critical Injury" must be reported to the Board's representative IMMEDIATELY.

23. SAFE SCHOOL PROCEDURES

Contractor's staff is required to report to the main office of each school during regular school hours and notify the school office staff of the purpose of the visit. The Contractor is required to adhere to all school specific procedures if applicable.

It is the responsibility of the Contractor's staff to sign in and sign out of the Log Book, which is located in the main office area, while performing their duties.

The following information must be recorded in a legible manner:

Date
Company Name
Employee Name
Employee Signature
Reason for Visit

Time Entering Building Time Leaving Building

24. PARKING

Contractors must park within the designated areas and allow for provisions to and from the designated parking area onto the job site.

25. TIE BIDS

In the event of a tie. A coin flip conducted by the Procurement Specialist with a minimum of one other Board staff will determine the successful proponent.

END OF INSTRUCTIONS TO BIDDERS

ST. CLAIR CATHOLIC DISTRICT SCHOOL BOARD EMERGENCY ROOF REPLACEMENT AREA 'S'

FOR

URSULINE COLLEGE CHATHAM
CATHOLIC SECONDARY SCHOOL
85 GRAND AVENUE WEST
CHATHAM, ONTARIO
N7L 1B6

TENDER FORM

PROJECT No. 725-CP1829

FEBRUARY 2018

Remlap Building Services Inc. 1407 Gore Road, RR1 – Harrow Ontario NOR 1H0

including provincial sales tax.

Emergency Roof Replacement for Ursuline College Chatham Catholic Secondary School Project № 725-CP1829

	(Hereinafter Called the Tendere	er Contractor)
Address		
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	Note: In space (A) above states t Eg. "Incorporated", "lim In space (B) above state	nited", etc.
stered under the laws of	the Province of	
DOES HEREBY AGRE	<u>EE TO:</u>	
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of Tender, and Drawing	air Catholic District School Board in gs by Remlap Building Services, 1407 EE "A" (H.S.T. INCLUDED),	Gore Road, RR1 Harrow, Ontario -
of Tender, and Drawing	s by Remlap Building Services, 1407	Gore Road, RR1 Harrow, Ontario -
of Tender, and Drawing	gs by Remlap Building Services, 1407 EE "A" (H.S.T. INCLUDED),	Gore Road, RR1 Harrow, Ontario -
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Remlap Building Services Inc. 1407 Gore Road, RR1 – Harrow Ontario NOR 1H0

Emergency Roof Replacement for Ursuline College Chatham Catholic Secondary School Project № 725-CP1829

Section "A"

Emergency Roof Replacement for Ursuline College Chatham Catholic Secondary School

The Bidder offers to provide all labour, materials and equipment services for the execution and completion of the work of the trade or trades herein and in accordance with the instructions for Bidders including Provincial Sales Tax for the stipulated sum of:

Mo. Description Poption No.1 (Peel&Stick V.R.) Option No.2 (10 mil Polyethelene) A. Roof Area 'S' As Indicated on Key Plan R-1 The Roofing Contractor is to remove the existing Roof System completely to the metal roof deck, then the Contractor is to supply and install Vapour Retarder (OPTION No.1 - Peel & Stick Membrane or OPTION No. 2 - 10 mil Polyethelene) as determined by the School Board, all rigid insulation, etc. prior to installing the Mechanically Attached EPDM Reinforced Membrane Single Ply Roof System as shown on the Enclosed Drawings and in accordance with the Project Specifications for this facility. (The Contractor will include a Cash Allowance of \$10,000.00 with this price (if the allowance is not used, it will be taken off of the Total Tender Price). \$ \$ Allowance for Emergency Roof Materials The Roofing Contractor is required to carry the following	<u>Item</u>				
A. Roof Area 'S' As Indicated on Key Plan R-1 The Roofing Contractor is to remove the existing Roof System completely to the metal roof deck, then the Contractor is to supply and install Vapour Retarder (OPTION No.1 – Peel & Stick Membrane or OPTION No. 2 – 10 mil Polyethelene) as determined by the School Board, all rigid insulation, etc. prior to installing the Mechanically Attached EPDM Reinforced Membrane Single Ply Roof System as shown on the Enclosed Drawings and in accordance with the Project Specifications for this facility. (The Contractor will include a Cash Allowance of \$10,000.00 with this price (if the allowance is not used, it will be taken off of the Total Tender Price). \$ Allowance for Emergency Roof Materials The Roofing Contractor is required to carry the following	No.	Description	<u>Total</u>		
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The Roofing Contractor is required to carry the following					
The Roofing Contractor is required to carry the following	R	Allowance for Emergency Roof Materials			
amount for the 75 mil Reinforced EPDM Membrane along		amount for the 75 mil Reinforced EPDM Membrane along			
with 2 inch SecurShield Polyiso Rigid Insulation Boards					
(4 feet x 4 feet in size) to cover the entire area (2 layers thick)					
as supplied by Beacon Roofing Supply - London for the amount of. \$ 24,686.88 \$ 24,686.88		11 9 11 9	¢ 2/ 686 88	¢ 24 686 88	
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Total Tender Price "A" (excluding HST) \$ \$		Total Tender Price "A" (excluding HST)	\$	\$	
Add 13% HST \$ \$		Add 13% HST	\$		
Total Tender Price "A" (including HST) \$ \$		Total Tender Price "A" (including HST)	\$	\$	
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SEPARATE PRICE - <u>Tapered Rigid Insulation Cost</u> The Contractor is to provide the Price to Supply and Install the					
Tapered Backslope Insulation as Indicated on Drawing UCC-R3a \$			\$		
(Excluding HST)	•		(Exc	cluding HST)	
Remlap Building Services Inc. 1407 Gore Road, RR1 – Harrow Ontario NOR 1H0		1 0			

Emergency Roof Replacement for Ursuline College Chatham Catholic Secondary School Project № 725-CP1829

MEN	BRANE MANUFACTURER - (SINGLE	PLY MECHANICALLY FASTENED ROOF SYSTEM)
	Contractor is required to submit the n nis Roof Replacement Project: ———	ame of the Membrane Manufacturer who they are planning to use
3.	And also agrees to submit the total te Information to Tenderers regarding H	ender price in compliance with the provisions of Section 1.21 of the larmonized Sales Tax (HST).
4.	•	for acceptance a minimum period of sixty (60) days from the tender raw, or cancel their bid during this period.
		ne form of Agreement is completed and executed, this Tender, together wner and the Tenderer, shall remain open regardless of whether or not y accepted.
5 .	And also agrees to start the entire wo	ork within four (4) working days after the award of contract.
6.	Documents and Acknowledgement	<u>ts</u>
	premises and conditions; and thorough	y have carefully examined the site of the proposed work, the existing ghly reviewed the Information to Tenderers, Tender Form, General Conditions, Specifications, Drawings and the Addenda of the proposed
	Addendum No	Date:
	Addendum No.	Date:
7.	Completion of Work	
	PHASE I – TO START FEBRUARY PHASE II – TO START MARCH 9 TH ,	15 TH , 2018 AND TO BE COMPLETED FEBRUARY 19 TH , 2018 2018 AND TO BE COMPLETED MARCH 19 TH , 2018.
8.	Subcontractors	
	being as indicated with no more than	llowing Subcontractors, the portion of the work to be performed by each one Subcontractor being proposed for any such portions. (If te N/A in the blank space.)
	Oubcontractors are not proposed, wit	

Emergency Roof Replacement for Ursuline College Chatham Catholic Secondary School Project № 725-CP1829

Signature of Authorized Officer	·	
Phone No.	Email	
Name of Signature		
Witness		
Dated at		
This	day of	2018

NOTES:

- 1. If this Tender is submitted by or on behalf of any Corporation by some duly authorized officer, or agent thereof, who shall subscribe their name and office, the Seal of the Corporation shall be affixed.
- 2. The Owner reserves the right to accept or reject any part OR all of bid and may not necessarily award the tender to the lowest bidder.

SPECIFICATION ON EMGERGENCY ROOF REPLACEMENT

FOR

ST. CLAIR CATHOLIC DISTRICT SCHOOL BOARD

AT

URSULINE COLLEGE CHATHAM CATHOLIC SECONDARY SCHOOL 85 GRAND AVENUE WEST CHATHAM, ONTARIO N7L 1B6

PROJECT No. 725-CP1829

FEBRUARY 2018

3.0 GENERAL

Emergency Roof Replacement
for
Ursuline College Chatham Catholic Secondary School
Project № 725-CP1829

3.1 Warranties

3.1.1 Roofing Application Guarantee

Warrant the work of this section including insulation, membrane and sheet metal work against defects and any actual leakage in accordance with the General Conditions but for a period of two (2) years and agree to make good promptly any defects which occur or become apparent within the warranty period, such defects to include but not be restricted to leaking, blistering, lifting, curling, wrinkling, alligatoring, fish mouths, loosening and splitting of seams, buckling of counter flashing, improper securement of flashings, improper use or application of materials.

3.1.2 <u>Membrane System Warranty</u>: (Mechanically Attached EPDM Reinforced Membrane Single Ply Roof System)

Provide a Written Membrane System Warranty to **St. Clair Catholic District School Board** – Emergency Roof Replacement stating that the Roofing Membrane Manufacturer will pay the entire cost to have the Authorized Roofing Applicator searches any leaks which occur due to Membrane or Application (workmanship) failure within the warranty period of fifteen years.

4.0 PRODUCTS – ROOF AREA 'S'

Emergency Roof Replacement for Ursuline College Chatham Catholic Secondary School Project № 725-CP1829

75 MIL REINFORCED EPDM MECHANICALLY FASTENED ROOF SYSTEM

4.1 General

4.1.1 The components of this roofing system are to be products of Carlisle or accepted by Carlisle as compatible or approved equal.

4.2 Membrane

4.2.1 Furnish Sure-Tough, 75 mil thick reinforced EPDM (Ethylene, Propylene Diene Terpolymer) conforming to the minimum physical properties of ASTM D4637, Type 11. The membrane shall be manufactured in a single panel with no factory splices to reduce splice intersections. EPDM membrane shall be ordered with Factory-Applied Tape.

4.3 Related Materials

4.3.1 Sure-Seal Reinforced Flashing, Bonding Adhesive, Water Cut-Off Mastic, EP-95 Spicing Cement, Weathered Membrane Cleaner, Molded Pocket Sealant, Pre-Molded Inside/Outside Corners, Pipe Flashings, Curb Wraps and Sealant Pockets.

4.4 Vapour Retarder

4.4.1 The Vapour Retarder shall consist of one of the following Options: (*Note*: The Contractor is required to submit a cost for both options listed below and the School Board will make a decision on which vapour retarder method they wish to be completed.

Option № 1

The vapour retarder shall be Carlisle Vap Air Seal 725 TR, 40 mil composite consisting of 35 mils of self-adhering rubberized asphalt laminated to a5 mil woven polypropylene film. A one-piece silicone poly release liner is applied to the SBS adhesive to prevent the material from bonding to itself.

Option № 2

The vapour retarder shall be Super 10 mil polyethelene applied over top of the metal deck shall comply with CGSB CAN2-S1.34-M86. Adhesive shall be of a type as recommended by the Polyethelene Manufacturer for adhesion at the side and end laps.

4.5 Rigid Insulation

4.5.1 Insulation shall be SecurShield Polyiso Rigid Insulation Boards with coated glass fiber mat facers on both sides, meeting or exceeding the requirements of ASTM C1289 (Minimum Compressive Strength of 20 psi (138 KPa). The thermal resistance of insulation for Areas 'S' shall be R-24.2 (L.T.T.R.) (2 layers of 2.0 inch for the main roof and R-12.1 (L.T.T.R.) (2 inch) around the recessed roof drains, resistance R-value in accordance with ASTM C1289-11A. All insulation boards shall be 4 feet by 4 feet in size.

4.0 PRODUCTS – ROOF AREA 'S'

Emergency Roof Replacement for Ursuline College Chatham Catholic Secondary School Project № 725-CP1829

4.6 Tapered Insulation

4.6.1 The tapered insulation shall be coated glass fiber mat facers Isocyanurate Boards conforming to ASTM C1289 meeting the requirements of ULC S126. Polyisocyanurate foam panels chemically bonded during the foaming process to facers on the top and bottom surfaces. Tapered panels shall not be less than 25 mm at any point of the roof to the slope indicated at the roof drains (2% slope) (2" to 1" for four feet around each drain). Backslope: (2% slope) (1 ½" to ½" for four feet around roof perimeter and penetrations as noted) and crickets (1% slope starting at ½" upward)

4.7 Fasteners, Plates, Bars

- 4.7.1 The fasteners shall be Carlisle HP Fasteners (2" in length for Russ securement strip) (3" in length for first layer of rigid insulation) (5" in length for securement of reinforced membrane at seams).
- 4.7.2 HP Polymer Seam Plates shall be 2 inch (51mm) diameter plastic barbed fastening plate used for membrane
- 4.7.3 Seam Fastening Plate shall be 2 inch (51mm) diameter metal plate for RUSS attachment
- 4.7.4 Insulation Fastening Plate shall be nominal 3 inch (76mm) diameter FM approved metal plate used for insulation attachment.
- 4.7.5 Sure-Seal Metal Fastening Bar shall be 1 inch by 10 feet long (25 mm x 3048 mm) Galvalume-coated steel fastening bar pre-punched 6 inches (152mm) on center for membrane securement as noted.

4.8 Insulation Adhesive

4.8.1 The adhesive to adhere second layer of rigid insulation to first layer of insulation shall be Fast 100, two-component, polyurethane low-rise expanding foam adhesive.

4.9 Vent Pipe Stack Flange

4.9.1 The vent pipe stack flange shall be Thaler Roofing Specialties Products Inc. Model № SJ-38 insulated flange. The Roofing Contractor shall verify the inside diameter of the vent pipe stack for each location. The flanges are required to be sealed to the roof membrane with Pre-molded Pressure Sensitive Pipe Seal in accordance with Carlisle U-8A Detail.

4.10 Roof Drain

4.10.1 The roof drain shall be Thaler Roof Specialties Products Inc. Model No. RD-4A-RR Vandal-Proof aluminum roof drain and under deck clamp. Drain is to be completed with Furco Connection. Outlet size shall be verified on site by the Roofing Contractor.

4.11 Framing Lumber

4.11.1 Framing lumber on top of roof area shall be Spruce conforming to CSA 0322-1976 and CSA 080-M1983. Size as shown on the project drawings. Grade SPF No. 2 or better.

4.0 PRODUCTS - ROOF AREA 'S'

Emergency Roof Replacement
for
Ursuline College Chatham Catholic Secondary School
Project № 725-CP1829

4.12 Plywood

4.12.1 Exterior grade fir to CSA 0121 or CSA 0151 to the thickness indicated on the project drawings.

4.13 Metal Flashings

4.13.1 Metal Flashings shall be 24ga Colorite 8000 Series pre-finished steel (both sides) as manufactured by Westeel Roscoe, Steelcolour 8000 Series or Owner approved equal, formed to comply with field conditions. The colour is to be brown as selected by the Owner from the manufacturer's standard colours. A one meter 'test bend' for each general metal flashing condition shall be completed and presented to the Owner's Representative for approval prior to general fabrication.

4.14 Painting

- 4.14.1 All existing gas lines, pipe stacks, exhaust fan hoods shall be cleaned and scraped prior to being repainted.
- 4.14.2 Clean and prime with alkyd metal primer before applying two coats of enamel paint. The colour shall match existing colour.

4.15 Concrete Pads

4.15.1 Precast Concrete Pads shall be 24 inch by 24 inch by 2 inch thick for additional walkway, etc. as show on Roof Plans. Pads shall be placed on a 20 inch by 20 inch by 1 inch thick section of Rigid Type 4 Extruded Polystyrene Insulation.

40 NEW CONCRETE PADS ARE REQUIRED IN TOTAL

4.16 Roof Pipe Supports

4.16.1 Roof Pipe Supports as manufactured by C-Pot (Model № CXP) are to be supplied and installed by the Roofing Contractor.

TOTAL OF **24** ARE REQUIRED @ URSULINE COLLEGE -CHATHAM

5.0 EXECUTION – ROOF AREA 'S'

Emergency Roof Replacement for Ursuline College Chatham Catholic Secondary School Project № 725-CP1829

75 MIL REINFORCED EPDM MECHANICALLY FASTENED ROOF SYSTEM

5.1 General

- 5.1.1 Comply with the manufacturer's published instructions for the installation of the membrane roofing system including proper substrate preparation, jobsite considerations and weather restrictions.
- 5.1.2 Position sheets to accommodate contours of the roof deck and shingle splices to avoid bucking water.

5.2 Installation of Vapour Retarder

- 5.2.1 Install vapour retarder only to clean, dry surfaces.
- 5.2.2 Vapour retarder is required to be enveloped over rigid insulation.
- 5.2.3 Vapour retarder is required to be laid directly on top of the metal roof deck.
- 5.2.4 Overlap on the side laps shall be no less than three (3) inches wide and end laps shall be at least six (6) inches wide with staggered joints.
- 5.2.5 A bead of sealant is required on all overlaps when 10 mil polyethelene is applied.

5.3 Insulation Placement and Attachment

- 5.3.1 Install insulation or membrane underlayment over the substrate with boards butted tightly together with no joints or gaps greater than 1/8 inch. Stagger joints both horizontally and vertically if multiple layers are provided.
- 5.3.2 Secure insulation to the substrate with the required mechanical fasteners in accordance with the manufacturer's specifications. (no less than 4 per board) (1st layer)
- 5.3.3 Install second layer of rigid insulation with Fast 100 Adhesive to the lower rigid insulation as indicated. On all insulation surfaces intended for board coverage, apply continuous stripes of 13 to 19mm (1/2" to 3/4") on 150mm (6") centers for twelve (12) feet around roof perimeter and 200mm (8") centers for the field of the roof.
- 5.3.4 Firmly set the second layer of rigid insulation boards into the strips of the Fast 100 Adhesive. All boards must be evenly and tightly butted together in stagger fashion.
- 5.3.5 Apply only as many boards as can be covered in the same day.

5.4 Membrane Placement and Attachment

- 5.4.1 Unroll and position membrane without stretching. Allow the membrane to relax for approximately 1/2 hour prior to attachment. Provide and secure both perimeter and field membrane sheets in accordance with the manufacturer's most current specifications and details.
- 5.4.2 Secure the membrane (along the pre-printed blue line approximately 3" from the edge of the membrane sheet) with the required Sure-Seal Fastener and 2" Polymer Seam Plate (required for steel decks) or Seam Fastening Plate spaced a maximum of 12" on center. The minimum distance between the edge of the fastening plate and the edge of the membrane must be 2 inches.

5.0 EXECUTION - ROOF AREA 'S'

Emergency Roof Replacement for Ursuline College Chatham Catholic Secondary School Project № 725-CP1829

- 5.4.3 Install adjoining membrane sheets in the same manner in accordance with the manufacturer's specifications.
- 5.4.4 Mechanically install fastener strip to all perimeter roof membrane and secure into the roof parapet with approved screw fasteners or RUSS (Reinforced Universal Securement Strip).
- 5.4.5 Bond roof membrane to the Reinforced Universal Securement Strip using splicing adhesive.

5.5 Membrane Splicing with SecurTape

- 5.5.1 Tape splices where fastening plates are located (along the length of the membrane) must utilize 6" wide SecurTape or FAT. Tape splices at end roll sections (along the width of the membrane without fastening plates) shall utilize 3" wide SecurTape.
- 5.5.2 Overlap adjacent sheets and mark a line approximately 1/4" to 1/2" from the top sheet edge.
- 5.5.3 Apply Sure-Seal HP-250 Primer to the splice area.
- 5.5.4 When Factory-Applied Tape (FAT) is not used, apply SecurTAPE in accordance with the manufacturer's specifications and roll the top sheet onto the mating surface.
- 5.5.5 Immediately roll the splice using positive pressure when using a 2" wide steel roller. Roll across the splice edge, not parallel to it. When using FAT, Carlisle's Stand-Up Seam Roller can be used to roll parallel to the splice edge.
- 5.5.6 All field splice seams are to be flashed in with 6"wide overlay Pressure Sensitive Flashing Membrane.
- 5.5.7 Lap sealant is required for all field splices. Feather the lap sealant with a specially performed tool so that the high point or the crown of the lap sealant is located over the edge of splice.

5.6 Flashing

- 5.6.1 Wall and curb flashing shall be cured EPDM membrane. Continue the deck membrane as wall flashing where practicable.
- 5.6.2 Follow manufacturer's typical flashing procedures for all wall, curb, and penetration flashing including metal edging/coping and roof drain applications.
- 5.6.3 Once the roof membrane is adhered to the securement strip, then bond the flashing membrane using bonding adhesive. Flashing membrane shall extend continuously up the entire height of the parapet over the parapet and down the exterior face as indicated on the enclosed drawings.

5.7 Installation of Metal Flashings

- 5.7.0 Cap flashings shall be jointed with a double S-type locked joint. Flashings shall be installed with continuous clips secured to the wood capping blocking at 12 inches on centre.
- 5.7.1 Flashings shall be fabricated to shapes on site with all necessary breaks for adequate expansion.

5.0 EXECUTION - ROOF AREA 'S'

Emergency Roof Replacement for Ursuline College Chatham Catholic Secondary School Project № 725-CP1829

5.7.2 The inside face of the metal cap flashing between the S-locked joint is to be secured with three (3) fasteners matching the colour of the metal cap with neoprene washer between the head and inside face of the metal cap flashing.

- 5.7.3 All joints shall be sealed with approved sealant.
- 5.7.4 Counter flashings shall be installed at all reglets and curbs with at least three (3) inches below top of roof curb or reglet.

5.8 Walkways

- 5.8.1 Install walkways in those locations as designated on the project drawings or as directed by Roof Consultant.
- 5.8.2 Install one inch extruded polystyrene rigid insulation over top the single ply membrane as indicated on the project drawings.
- 5.8.3 Then install the concrete pavers as specified on top the rigid insulation as indicated on the roof plan.

5.9 Daily Seal

- 5.9.1 On phased roofing, when the completion of flashings and terminations is not achieved by the end of the work day, a daily seal must be performed to temporarily close the membrane to prevent water infiltration.
- 5.9.2 Complete an acceptable membrane seal in accordance with the manufacturer's requirements.

5.10 Clean Up

- 5.10.1 Perform daily clean-up to collect all wrappings, empty containers, paper, and other debris from the project site. Upon completion, all debris must be disposed of in a legally acceptable manner.
- 5.10.2 Prior to the manufacturer's inspection for warranty, the applicator must perform a pre-inspection to review all work and to verify all flashing has been completed as well as the application of all caulking.

EMERGENCY ROOF REPLACEMENT URSULINE COLLEGE CHATHAM CATHOLIC SECONDARY SCHOOL 85 GRAND AVENUE WEST CHATHAM ONTARIO N7L 1B6

PROJECT № 725-CP1829

ENCLOSED DRAWINGS

UCC-B UCC-R1	Existing and Proposed Roof System List Key Roof Plan
UCC-R3	Enlarged Roof Plan – Area 'S' (Roof Penetration and Dimensions)
UCC-R3a	Enlarged Roof Plan – Area 'S' (Tapered Insulation Layout)
UCC-D1	Roof Drain Detail – Typical
UCC-D2	Vent Pipe Stack Detail - Typical
UCC-D3	Gooseneck Exhaust Fan – Typical
UCC-D19	Perimeter Wall Detail – Area 'S'
UCC-D20	Detail @ Man Door Entry onto Area 'S'
UCC-D21	Perimeter Wall Detail – Area 'S'
UCC-D22	Perimeter Wall Detail – Area 'S'
UCC-D23	Perimeter Wall Detail – Area 'S'
UCC-D24	Wall Ladder Detail – Leading to Area 'S'
UCC-D25	Detail @ Skylight – Area 'S'
UCC-D26	New Platform Detail Beneath Roof Top Unit @ Canopy – Area 'S'
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EMERGENCY ROOF REPLACEMENT URSULINE COLLEGE CHATHAM CATHOLIC SECONDARY SCHOOL 85 GRAND AVENUE WEST CHATHAM ONTARIO N7L 1B6


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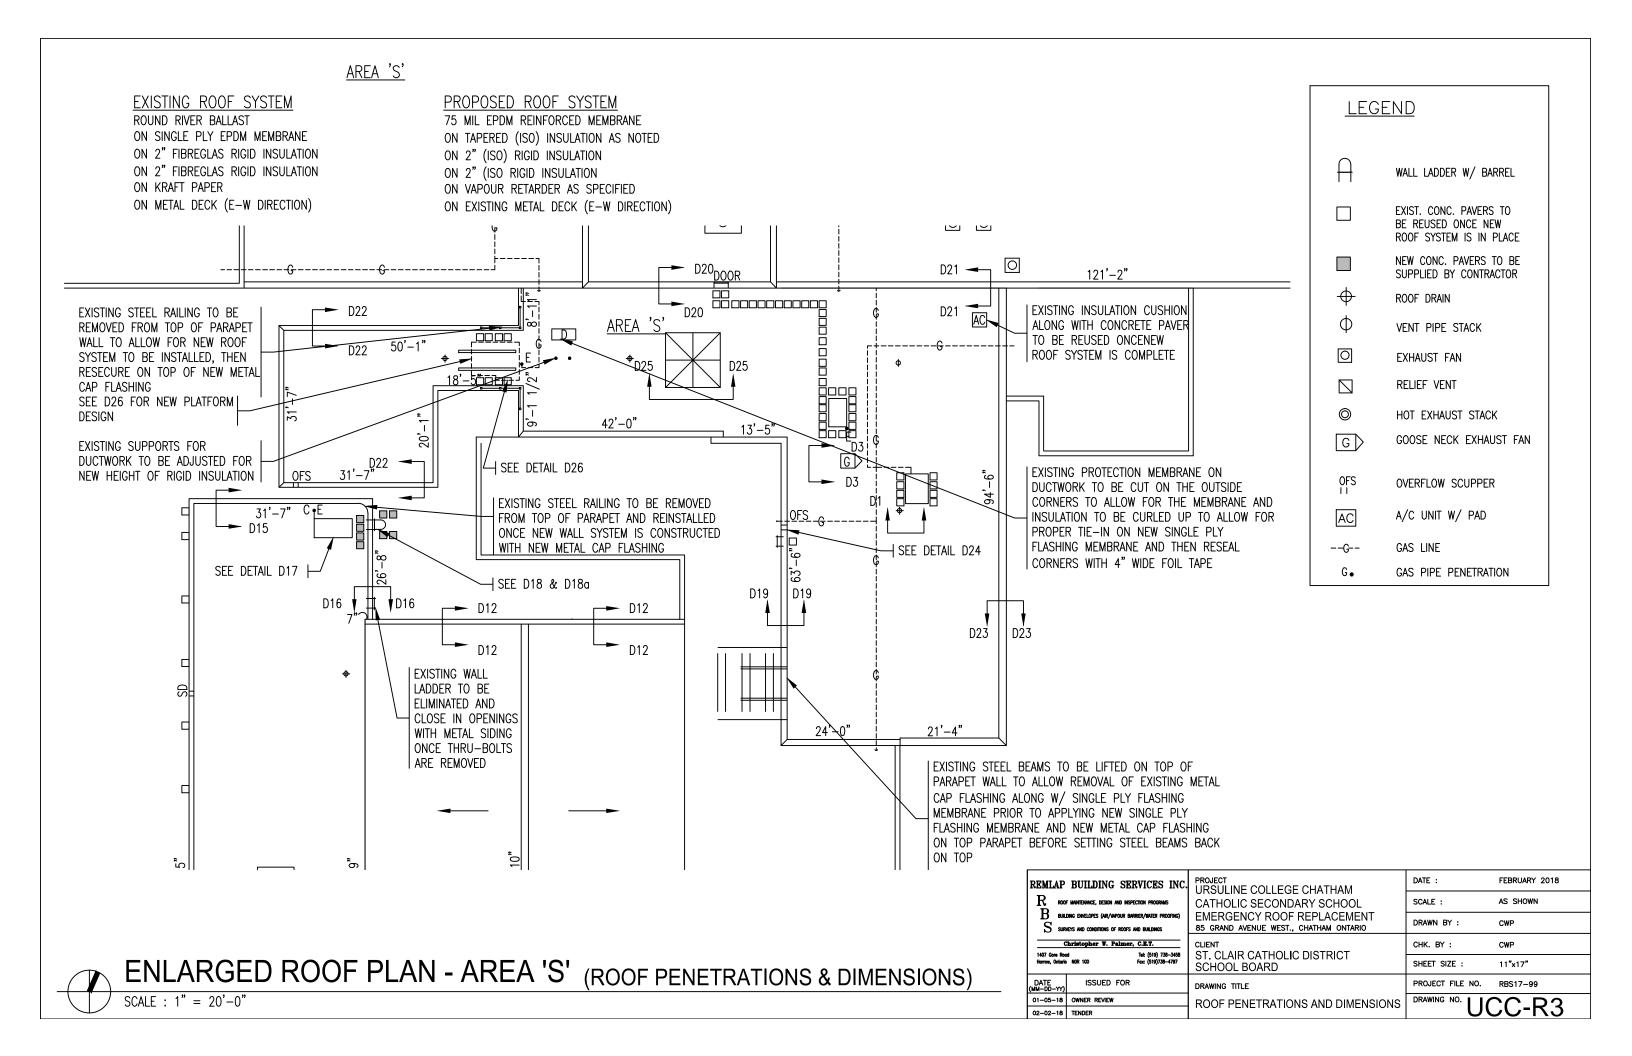
EXISTING ROOF SYSTEM


DESIGN ROOF SYSTEM


AREA 'S'

Round River Ballast On Single Ply EPDM Membrane On 2" Fibreglass Rigid Insulation On 2" Fibreglass Rigid Insulation On Kraft Vapour Retarder On Metal Deck (E-W Direction) 75 Mil EPDM Reinforced Membrane
On Tapered (ISO) Rigid Insulation as Noted
On 2" (ISO) Rigid Insulation
On 2" (ISO) Rigid Insulation
On Vapour Retarder as Specified
On Existing Metal Deck (E-W Direction)



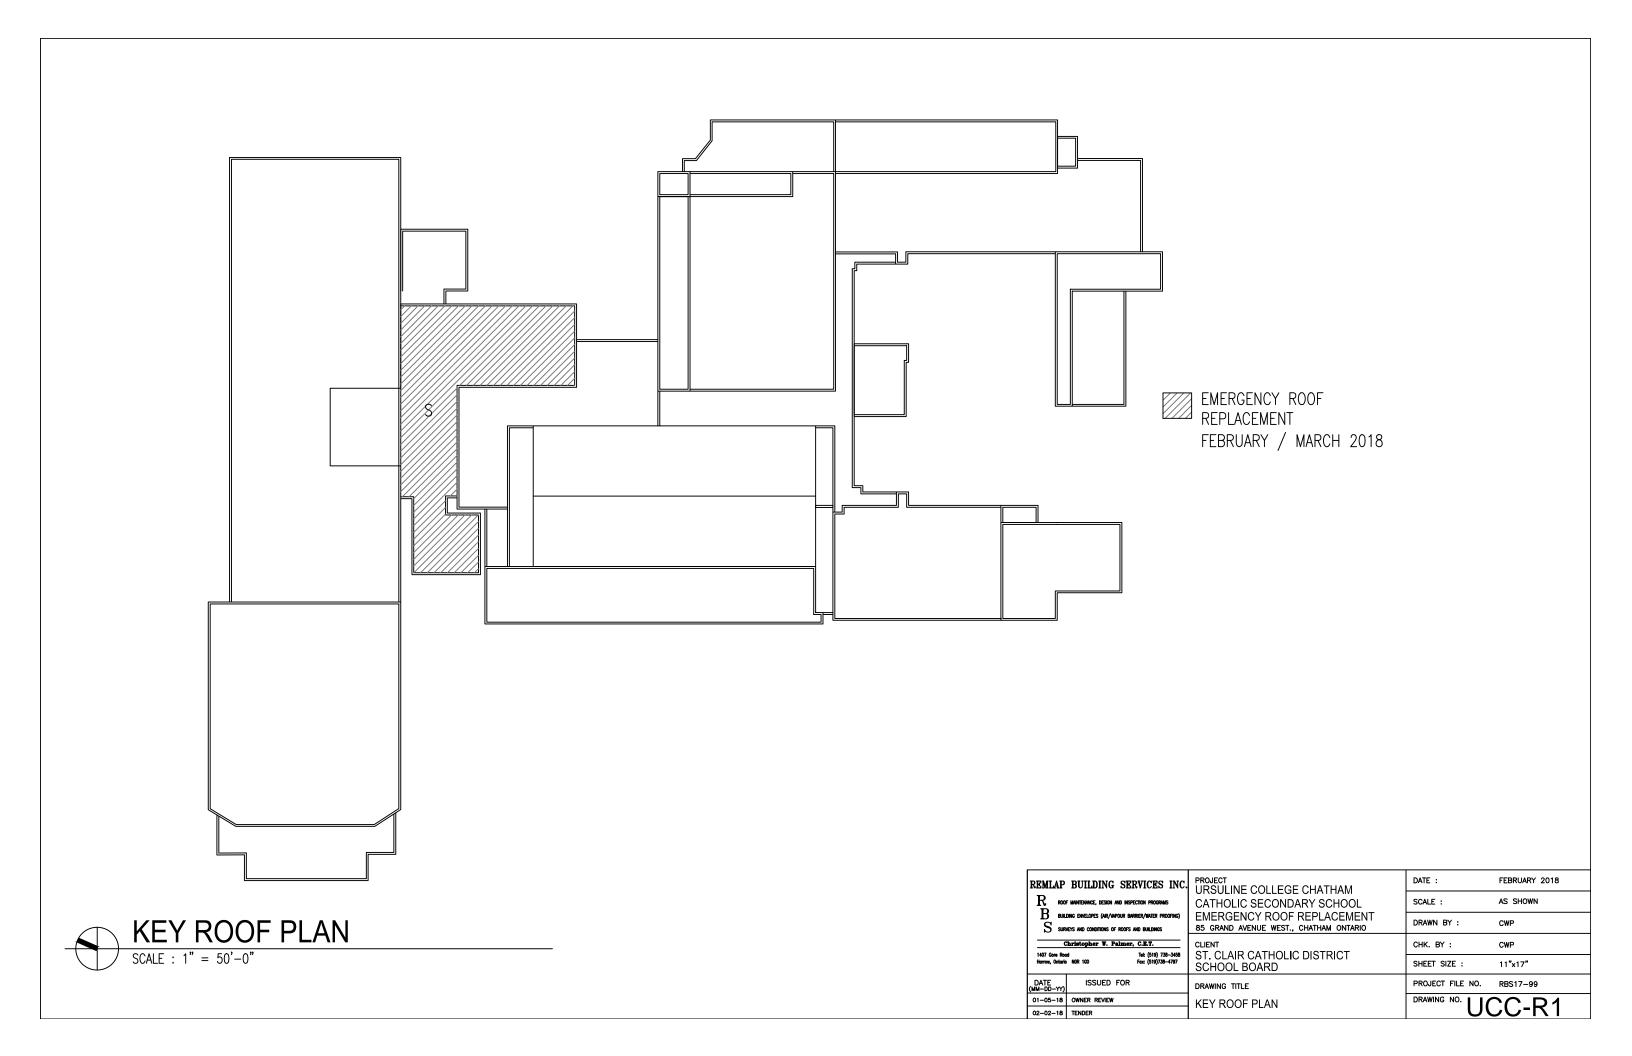

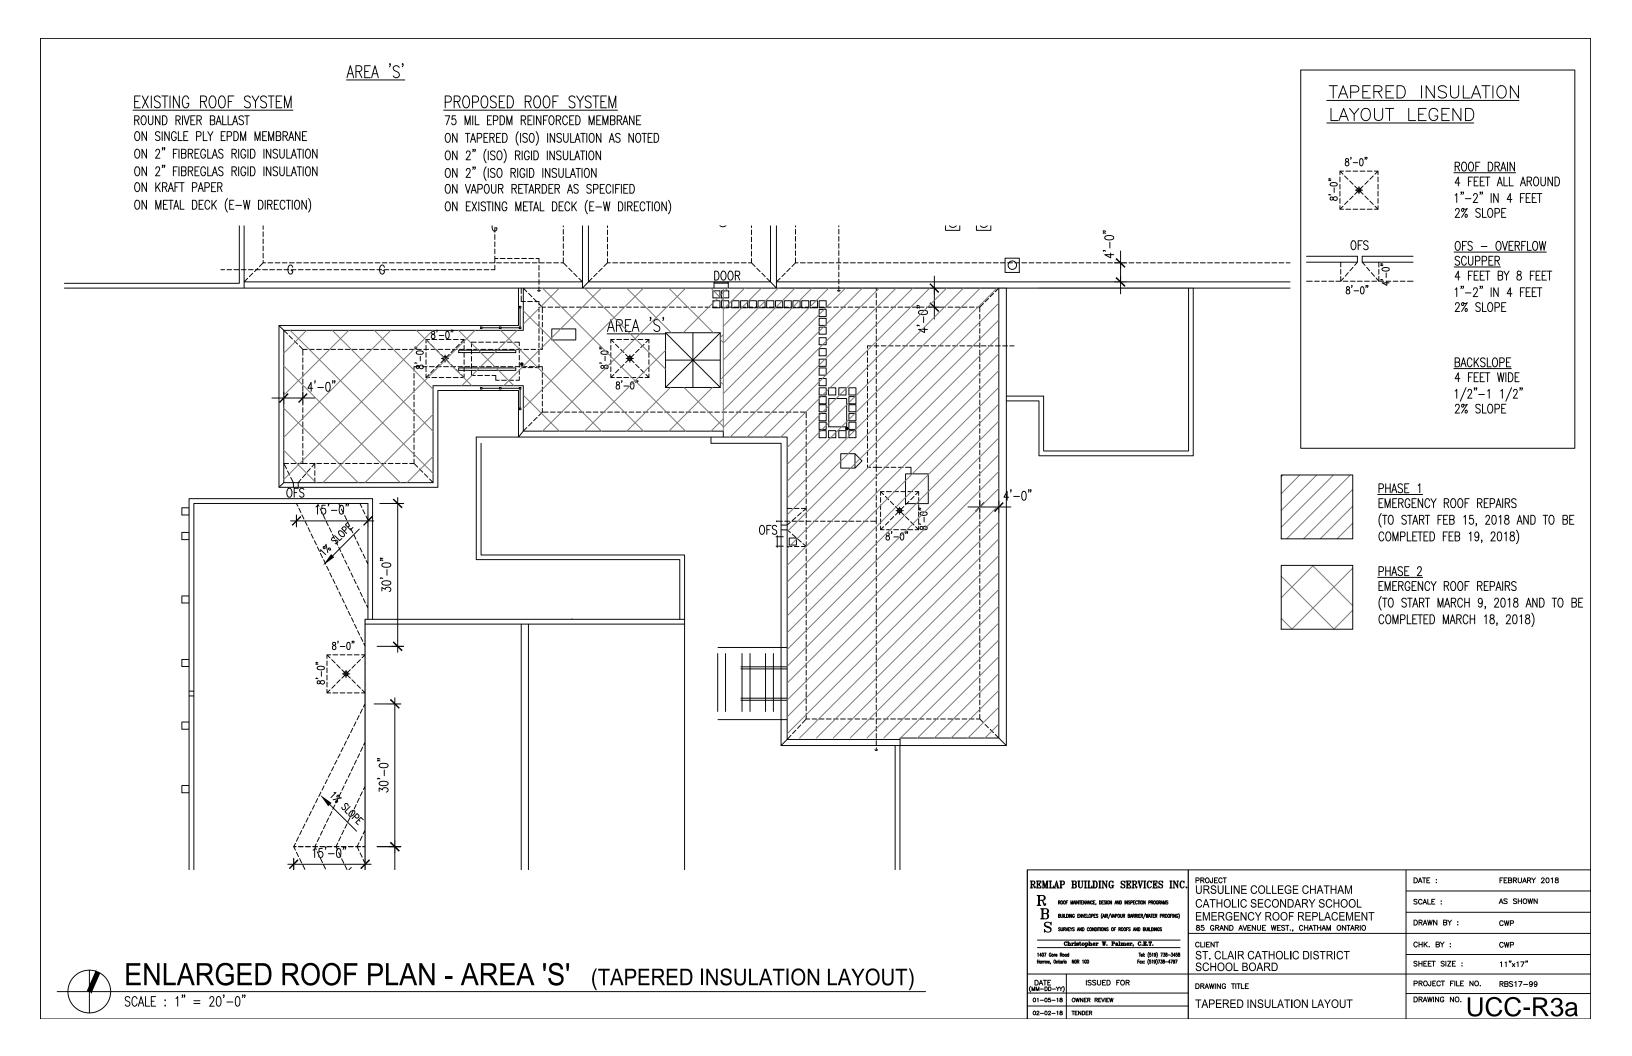


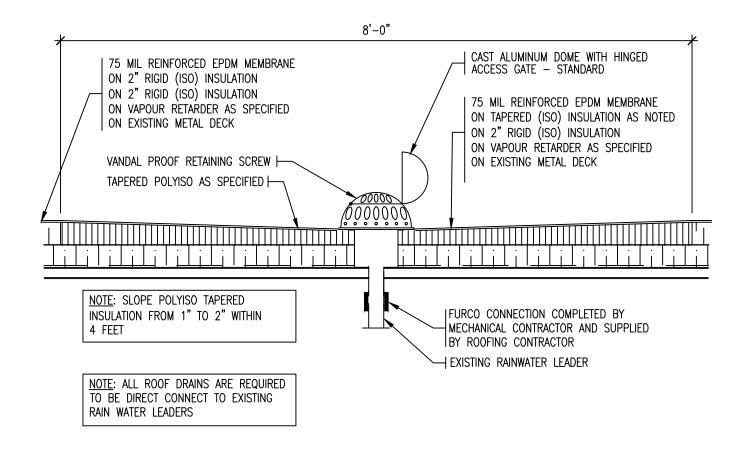

ROOF DRAIN DETAIL - TYPICAL

SCALE : 1'' = 1'-0''

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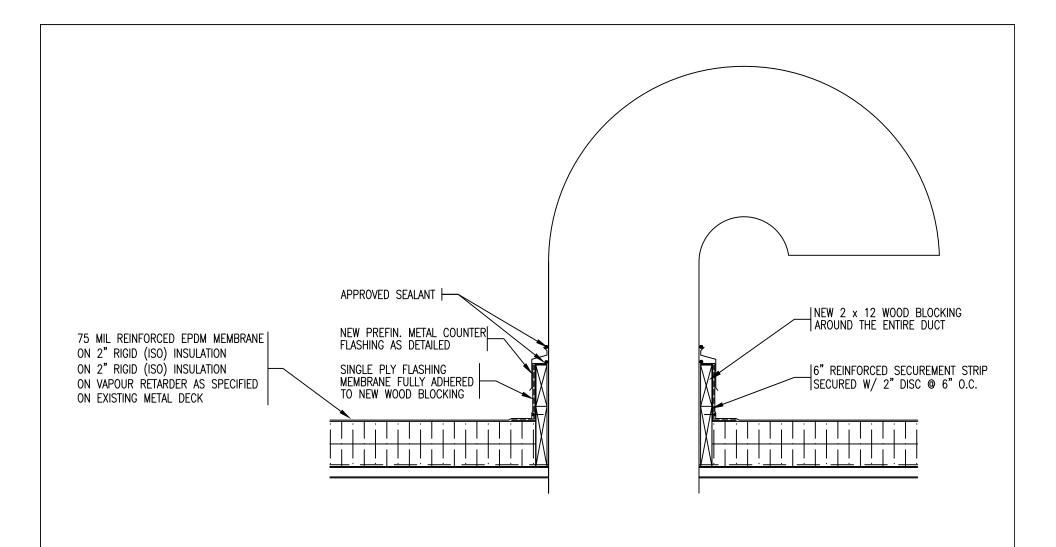


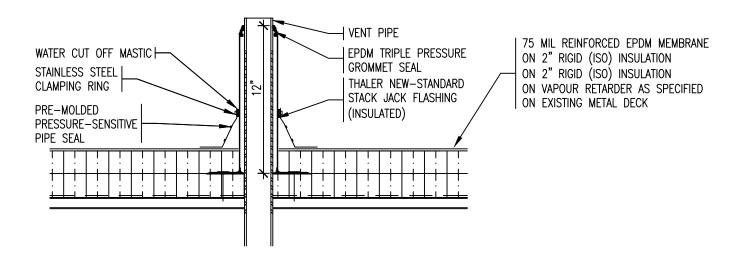NOTE:

IF EXISTING VENT STACK IS NOT HIGHER THAN THE NEW SJ-38, THE CONTRACTOR IS REQUIRED TO EXTEND A MINIMUM OF 3" ABOVE EPDM GROMMET SEAL


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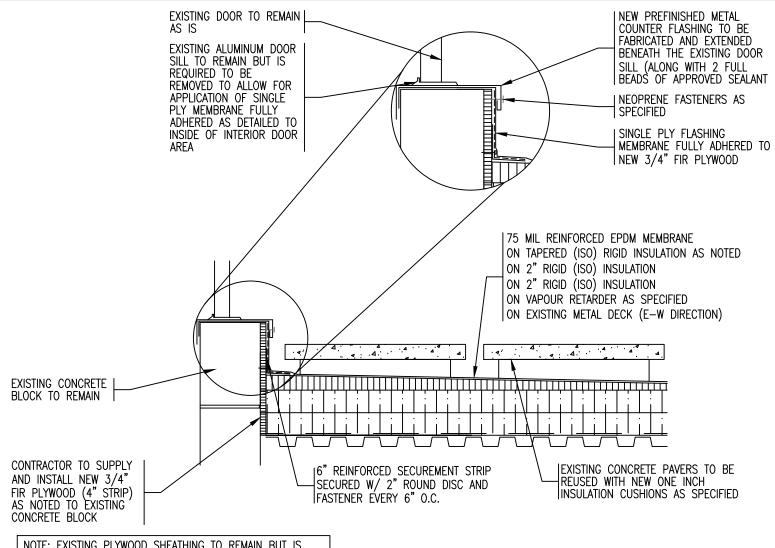
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NOTE: EXISTING PLYWOOD SHEATHING TO REMAIN BUT IS REQUIRED TO BE SECURED TO CONCRETE BLOCK BEYOND WITH ADDITIONAL 1/4" CONCRETE FASTENERS (EVERY 2' O.C. TOP AND BOTTOM STAGGERED) TO ENSURE SHEATHING IS ADHERED TO SUBSTRATE BEYOND PRIOR TO INSTALLING NEW ROOF SYSTEM

PERIMETER WALL DETAIL - AREA 'S'


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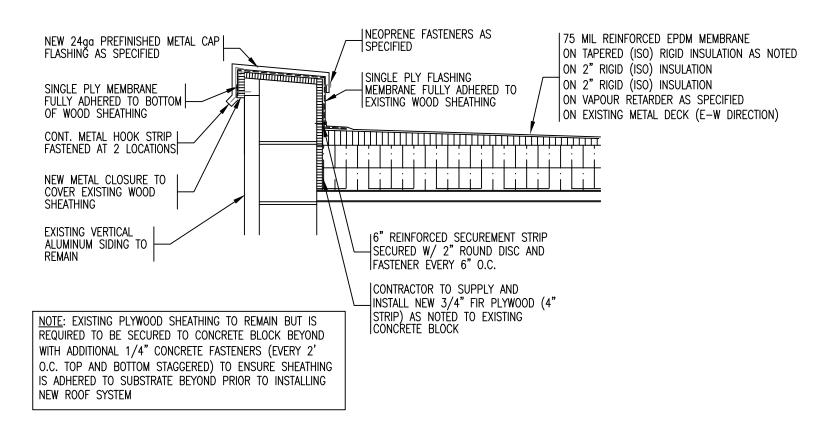
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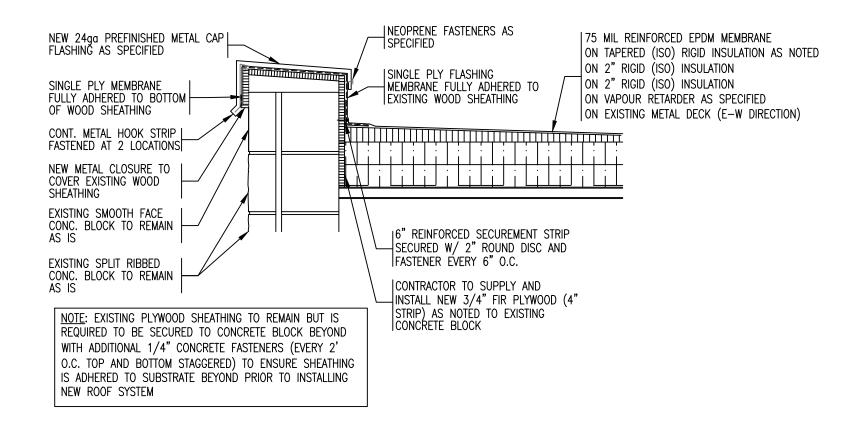
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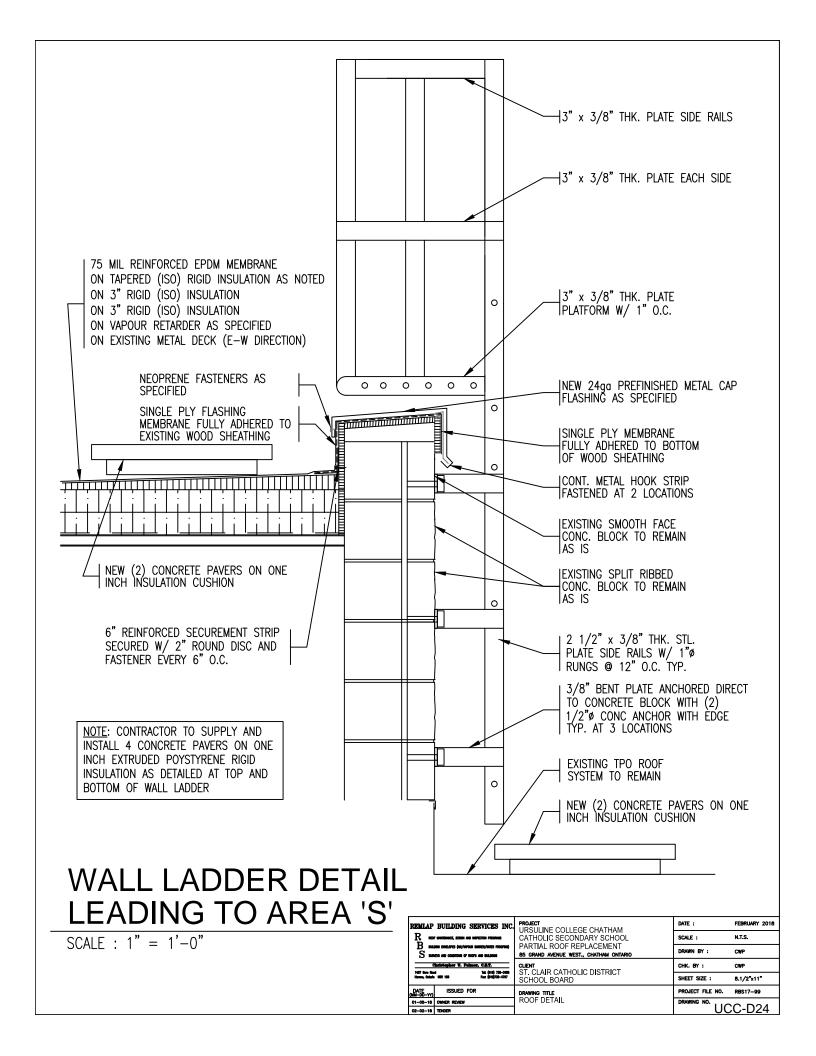
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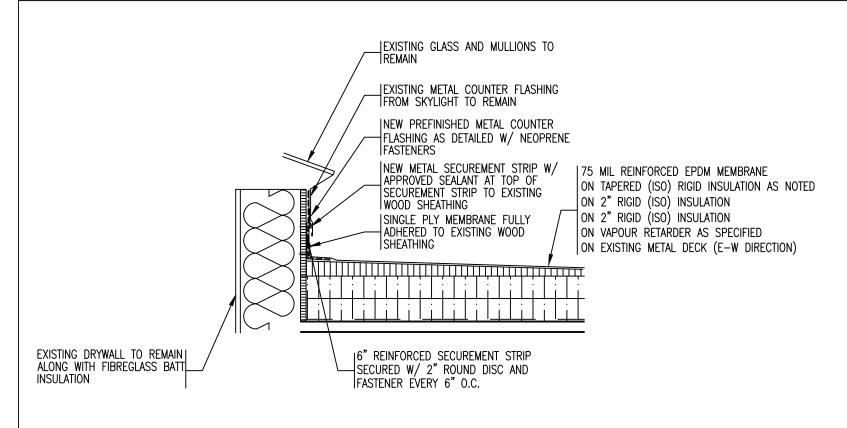
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			SHEET SIZE :	8.1/2"x11"
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01-05-18	OWNER REVIEW	ROOF DETAIL	DRAWING NO. UCC-D23	
02-02-18	TENDER			




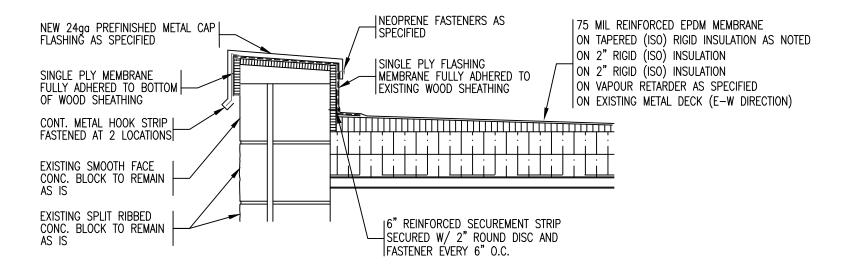

NOTE: EXISTING BOTTOM METAL COUNTER FLASHING
AROUND THE ENTIRE SKYLIGHT IS TO BE REMOVED TO
ALLOW FOR INSTALLATION OF NEW EPDM MEMBRANE FULLY
BONDED TO WOOD SHEATHING AND THEN TERMINATED WITH
METAL SECUREMENT STRIP WITH SEALANT ALONG THE TOP
PRIOR TO INSTALLING NEW METAL COUNTER FLASHING UP
BENEATH THE METAL COUNTER FLASHING ATTACHED TO THE
BOTTOM OF SKYLIGHT

DETAIL AT SKYLIGHT - AREA 'S'

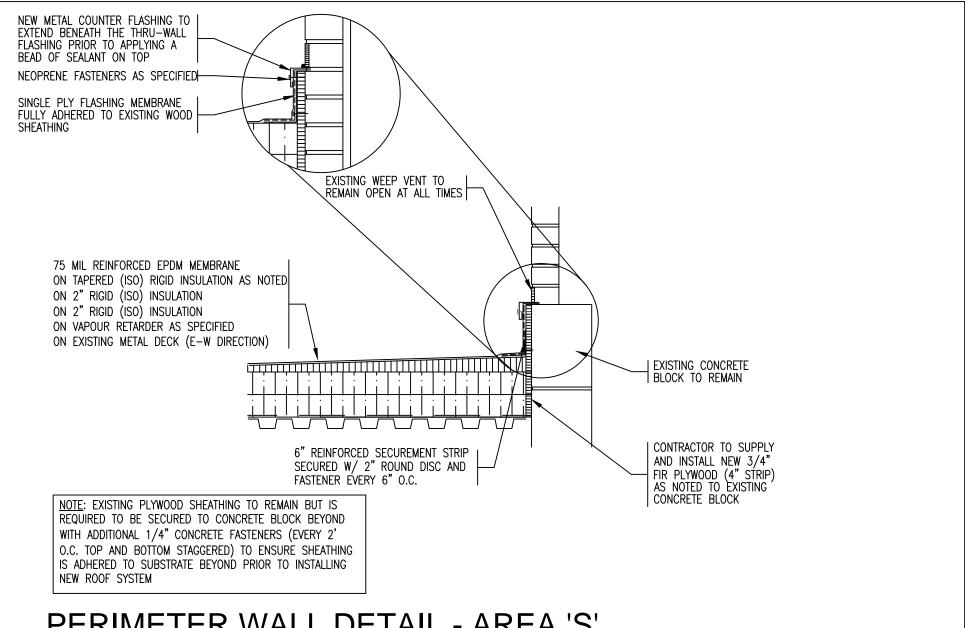REMLAP BUILDING SERVICES INC.	PROJECT URSULINE COLLEGE CHATHAM CATHOLIC SECONDARY SCHOOL EMERGENCY ROOF REPLACEMENT 85 GRAND AVENUE WEST., CHATHAM ONTARIO	DATE :	FEBRUARY 2018
R наи милана, каки на начала накажа		SCALE :	N.T.S.
B SULDING DIRECTES (NO/MPCUR BARRES/MICES PROCESSIS) S SURCES AND COMMISSION OF ROOTS AND MILLIONS		DRAWN BY :	CWP
Christopher W. Falmer, C.E.T.	CLIENT ST. CLAIR CATHOLIC DISTRICT SCHOOL BOARD	CHK. BY:	CWP
Harrow, Catalia MER 100 Fac (\$10)730-4707		SHEET SIZE :	8.1/2"x11"
DATE (NM-DD-YY) ISSUED FOR	DRAWING TITLE	PROJECT FILE NO.	RBS17-99
01-05-18 OWNER REVIEW	ROOF DETAIL	DRAWING NO. UCC-D25	
02-02-18 TENDER			

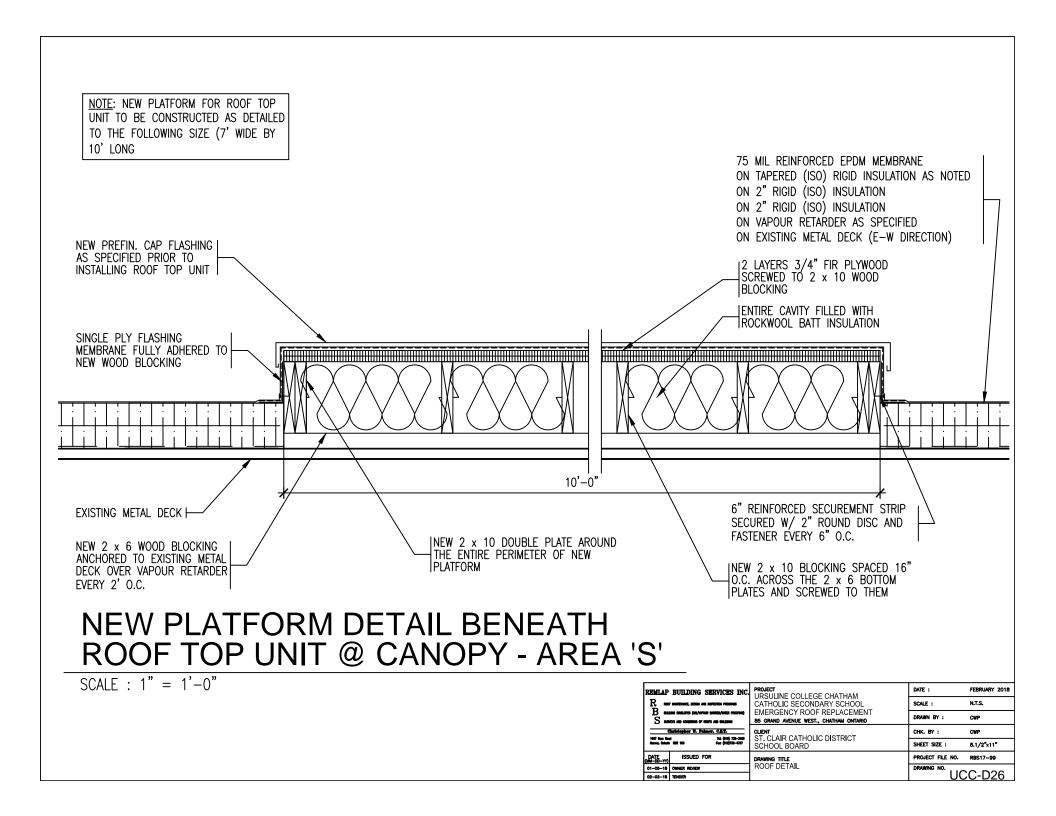

ST. CLAIR CATHOLIC DISTRICT SCHOOL BOARD PARTIAL ROOF REPLACEMENT AREA 'K' AND 'P'

FOR

URSULINE COLLEGE CHATHAM
CATHOLIC SECONDARY SCHOOL
85 GRAND AVENUE WEST
CHATHAM, ONTARIO
N7L 1B6

TENDER FORM

PROJECT No. 725-CP1831

FEBRUARY 2018

Remlap Building Services Inc. 1407 Gore Road, RR1 – Harrow Ontario NOR 1H0

Partial Roof Replacement for Ursuline College Chatham Catholic Secondary School Project № 725-CP1831

ranio oi biddo	er(Her	einafter Called the Tende		
Address				
Being A		(A) whi	ch	(B)
		space (A) above states Eg. "Incorporated", "li In space (B) above stat	mited", etc.	
gistered under the law	s of the Provinc	e of		
DOES HEREBY A	AGREE TO:			
Furnish all labour,	materials equipm	nent and service neces	cary for the comple	etion of the Partial Poof
Replacement at S	it. Clair Catholic awings by Remlar	District School Board Building Services, 140	in accordance wit 7 Gore Road, RR1	th Information of Tenderers 1 Harrow, Ontario – N0R 1
Replacement at S of Tender, and Dra	it. Clair Catholic awings by Remlar	District School Board Building Services, 140 T. INCLUDED),	in accordance wit 7 Gore Road, RR1	th Information of Tenderers
Replacement at S of Tender, and Dra	t. Clair Catholic awings by Remlar PRICE "A" (H.S.	District School Board Building Services, 140 T. INCLUDED),	in accordance wit 7 Gore Road, RR1	th Information of Tenderers 1 Harrow, Ontario – N0R 1 (HST Included)
Replacement at S of Tender, and Dra	t. Clair Catholic awings by Remlar PRICE "A" (H.S.	District School Board b Building Services, 140 T. INCLUDED),	in accordance wit 7 Gore Road, RR1	th Information of Tenderers 1 Harrow, Ontario – N0R 1
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or such other sums Replacement and And also agrees the Material Payment	At. Clair Catholic awings by Remlap PRICE "A" (H.S. Option № 1 Option № 2 Is as may be finall deductions as set and upon Tender a Bond and Liability	District School Board	sance with the allow uments. Performance and I by the Contract Do	th Information of Tenderers 1 Harrow, Ontario – N0R 1 (HST Included) (HST Included)
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Stipulated prices shall include all labour, equipment and materials required to complete the work in every respect, including provincial sales tax.

Partial Roof Replacement for Ursuline College Chatham Catholic Secondary School Project № 725-CP1831

Section "A"

Item

Partial Roof Replacement for Ursuline College Chatham Catholic Secondary School

The Bidder offers to provide all labour, materials and equipment services for the execution and completion of the work of the trade or trades herein and in accordance with the instructions for Bidders including Provincial Sales Tax for the stipulated sum of:

<u>No.</u>	<u>Description</u>	<u>Ta</u>	<u>otal</u>
	_	Option No.1 (Peel&Stick V.R.)	Option No.2 (10 mil Polyethelene)
Α.	Doof Aven ID!	(Peel&Stick V.R.)	(10 mii Polyethelene)
A.	Roof Area 'P' As Indicated on Key Plan R-1a		
	The Roofing Contractor is to remove the existing Roof		
	System completely to the metal roof deck, then the		
	Contractoris to supply and install Vapour Retarder		
	(OPTION No.1 – Peel & Stick Membrane or OPTION No. 2 – 10 mil Polyethelene) as determined by the School Board,		
	all rigid insulation, etc. prior to installing the Mechanically		
	Attached EPDM Reinforced Membrane Single Ply Roof		
	System as shown on the Enclosed Drawings and in		
	accordance with the Project Specifications for this facility. (The Contractor will include a Cash Allowance of \$10,000.00		
	with this price (if the allowance is not used, it will be taken off		
	of the Total Tender Price).	\$	\$
В.	Roof Area 'K'		
	As Indicated on Key Plan R-1a		
	The Roofing Contractor is to supply and install all Rigid		
	Insulation, Protection Board, etc. prior to installing a Two Ply Modified Bitumen Roof System as shown on the Enclosed		
	Drawings and in accordance with the Project Specifications		
	for this facility. (The Contractor will include a Cash Allowance		
	of \$10,000.00 with this price (if the allowance is not used, it will be taken off of the Total Tender Price).	\$	¢
	be taken on or the Total Tender Price.	Φ	⊅
	Total Tender Price "A" (excluding HST)	\$	\$
	Add 13% HST	\$	\$
	Total Tender Price "A" (including HST)	\$	\$
	(1 1 1 1 1 1 1 1 1 1 1 1 1 1 1 1 1 1 1	•	<u> </u>
	RATE PRICE - <u>Tapered Rigid Insulation Cost</u>		
	ontractor is to provide the Price to Supply and Install the ed Backslope Insulation as Indicated on Drawing UCC-R4a	\$	
. aport		Ψ(Exc	cluding HST)
	Remlap Building Services Inc.	NOR 1HO	

Partial Roof Replacement for Ursuline College Chatham Catholic Secondary School Project № 725-CP1831

MEMB	RANE MANUFACTURER - (SINGLE PLY MEC	HANICALLY FASTENED ROOF SYSTEM)
	ontractor is required to submit the name of the second Replacement Project:	e Membrane Manufacturer who they are planning to use
MEMB	RANE MANUFACTURER – (TWO PLY MECHA	NICALLY FASTENED ROOF SYSTEM)
	ontractor is required to submit the name of the second Replacement Project:	e Membrane Manufacturer who they are planning to use
3.	And also agrees to submit the total tender price Information to Tenderers regarding Harmonized	in compliance with the provisions of Section 1.21 of the Sales Tax (HST).
4.	And agrees to leave this tender open for accept closing date and not to modify, withdraw, or car	cance a minimum period of sixty (60) days from the tender neel their bid during this period.
		Agreement is completed and executed, this Tender, together he Tenderer, shall remain open regardless of whether or not it.
5 .	And also agrees to start the entire work within for	our (4) working days after the award of contract.
6.	Documents and Acknowledgements	
	premises and conditions; and thoroughly review	efully examined the site of the proposed work, the existing yed the Information to Tenderers, Tender Form, General, Specifications, Drawings and the Addenda of the proposed
	Addendum No.	Date:
	Addendum No.	Date:
7.	Completion of Work	
	We undertake to complete the work inwe issued by St. Clair Catholic School Board.	eeks after Receipt of Purchase Order or Written Authorization

To start work on <u>JULY 3RD</u>, <u>2018</u> and to complete the work by <u>AUGUST 31ST</u>, <u>2018</u>

Partial Roof Replacement for Ursuline College Chatham Catholic Secondary School Project № 725-CP1831

8. <u>Subcontractors</u>

The Tenderer proposes to use the following Subcontractors, the portion of the work to be performed by each being as indicated with no more than one Subcontractor being proposed for any such portions. (If Subcontractors are not proposed, write N/A in the blank space.)

SUBCONTRAC	IOR	WORK OR TRADE	
Signature of Authorized Officer			
Phone No.	Email		
Name of Signature			
Witness			
Dated at			
This	day of		2018

NOTES:

- 1. If this Tender is submitted by or on behalf of any Corporation by some duly authorized officer, or agent thereof, who shall subscribe their name and office, the Seal of the Corporation shall be affixed.
- 2. The Owner reserves the right to accept or reject any part OR all of bid and may not necessarily award the tender to the lowest bidder.

SPECIFICATION ON PARTIAL ROOF REPLACEMENT AREA 'K' AND 'P'

FOR

ST. CLAIR CATHOLIC DISTRICT SCHOOL BOARD

AT

URSULINE COLLEGE CHATHAM CATHOLIC SECONDARY SCHOOL 85 GRAND AVENUE WEST CHATHAM, ONTARIO N7L 1B6

PROJECT No. 725-CP1831

FEBRUARY 2018

3.0 GENERAL

Partial Roof Replacement
for
Ursuline College Chatham Catholic Secondary School
Project № 725-CP1831

3.1 Warranties

3.1.1 Roofing Application Guarantee

Warrant the work of this section including insulation, membrane and sheet metal work against defects and any actual leakage in accordance with the General Conditions but for a period of two (2) years and agree to make good promptly any defects which occur or become apparent within the warranty period, such defects to include but not be restricted to leaking, blistering, lifting, curling, wrinkling, alligatoring, fish mouths, loosening and splitting of seams, buckling of counter flashing, improper securement of flashings, improper use or application of materials.

3.1.2 <u>Membrane System Warranty</u>: (Two Ply Modified Bitumen Roof System)

Provide a Written Membrane System Warranty to **St. Clair Catholic District School Board** – Partial Roof Replacement stating that the Roofing Membrane Manufacturer will pay the entire cost to have the Authorized Roofing Applicator searches any leaks which occur due to Membrane or Application (workmanship) failure within the warranty period of fifteen years.

3.1.3 <u>Membrane System Warranty</u>: (Mechanically Attached EPDM Reinforced Membrane Single Ply Roof System)

Provide a Written Membrane System Warranty to **St. Clair Catholic District School Board** – Partial Roof Replacement stating that the Roofing Membrane Manufacturer will pay the entire cost to have the Authorized Roofing Applicator searches any leaks which occur due to Membrane or Application (workmanship) failure within the warranty period of fifteen years.

4.0 PRODUCTS – ROOF AREA 'P'

Partial Roof Replacement for Ursuline College Chatham Catholic Secondary School Project № 725-CP1831

75 MIL REINFORCED EPDM MECHANICALLY FASTENED ROOF SYSTEM

4.1 General

4.1.1 The components of this roofing system are to be products of Carlisle or accepted by Carlisle as compatible or approved equal.

4.2 Membrane

4.2.1 Furnish Sure-Tough, 75 mil thick reinforced EPDM (Ethylene, Propylene Diene Terpolymer) conforming to the minimum physical properties of ASTM D4637, Type 11. The membrane shall be manufactured in a single panel with no factory splices to reduce splice intersections. EPDM membrane shall be ordered with Factory-Applied Tape.

4.3 Related Materials

4.3.1 Sure-Seal Reinforced Flashing, Bonding Adhesive, Water Cut-Off Mastic, EP-95 Spicing Cement, Weathered Membrane Cleaner, Molded Pocket Sealant, Pre-Molded Inside/Outside Corners, Pipe Flashings, Curb Wraps and Sealant Pockets.

4.4 Vapour Retarder

4.4.1 The Vapour Retarder shall consist of one of the following Options: (*Note*: The Contractor is required to submit a cost for both options listed below and the School Board will make a decision on which vapour retarder method they wish to be completed.

Option № 1

The vapour retarder shall be Carlisle Vap Air Seal 725 TR, 40 mil composite consisting of 35 mils of self-adhering rubberized asphalt laminated to a5 mil woven polypropylene film. A one-piece silicone poly release liner is applied to the SBS adhesive to prevent the material from bonding to itself.

Option № 2

The vapour retarder shall be Super 10 mil polyethelene applied over top of the metal deck shall comply with CGSB CAN2-S1.34-M86. Adhesive shall be of a type as recommended by the Polyethelene Manufacturer for adhesion at the side and end laps.

4.5 Rigid Insulation

4.5.1 Insulation shall be SecurShield Polyiso Rigid Insulation Boards with coated glass fiber mat facers on both sides, meeting or exceeding the requirements of ASTM C1289 (Minimum Compressive Strength of 20 psi (138 KPa). The thermal resistance of insulation for Areas 'S' shall be R-24.2 (L.T.T.R.) (2 layers of 2.0 inch for the main roof and R-12.1 (L.T.T.R.) (2 inch) around the recessed roof drains, resistance R-value in accordance with ASTM C1289-11A. All insulation boards shall be 4 feet by 4 feet in size.

4.0 PRODUCTS – ROOF AREA 'P'

Partial Roof Replacement
for
Ursuline College Chatham Catholic Secondary School
Project № 725-CP1831

4.6 Tapered Insulation

4.6.1 The tapered insulation shall be coated glass fiber mat facers Isocyanurate Boards conforming to ASTM C1289 meeting the requirements of ULC S126. Polyisocyanurate foam panels chemically bonded during the foaming process to facers on the top and bottom surfaces. Tapered panels shall not be less than 25 mm at any point of the roof to the slope indicated at the roof drains (2% slope) (2" to 1" for four feet around each drain). Backslope: (2% slope) (1 ½" to ½" for four feet around roof perimeter and penetrations as noted) and crickets (1% slope starting at ½" upward)

4.7 Fasteners, Plates, Bars

- 4.7.1 The fasteners shall be Carlisle HP Fasteners (2" in length for Russ securement strip) (3" in length for first layer of rigid insulation) (5" in length for securement of reinforced membrane at seams).
- 4.7.2 HP Polymer Seam Plates shall be 2 inch (51mm) diameter plastic barbed fastening plate used for membrane
- 4.7.3 Seam Fastening Plate shall be 2 inch (51mm) diameter metal plate for RUSS attachment
- 4.7.4 Insulation Fastening Plate shall be nominal 3 inch (76mm) diameter FM approved metal plate used for insulation attachment.
- 4.7.5 Sure-Seal Metal Fastening Bar shall be 1 inch by 10 feet long (25 mm x 3048 mm) Galvalume-coated steel fastening bar pre-punched 6 inches (152mm) on center for membrane securement as noted.

4.8 Insulation Adhesive

4.8.1 The adhesive to adhere second layer of rigid insulation to first layer of insulation shall be Fast 100, two-component, polyurethane low-rise expanding foam adhesive.

4.9 Vent Pipe Stack Flange

4.9.1 The vent pipe stack flange shall be Thaler Roofing Specialties Products Inc. Model № SJ-38 insulated flange. The Roofing Contractor shall verify the inside diameter of the vent pipe stack for each location. The flanges are required to be sealed to the roof membrane with Pre-molded Pressure Sensitive Pipe Seal in accordance with Carlisle U-8A Detail.

4.10 Roof Drain

4.10.1 The roof drain shall be Thaler Roof Specialties Products Inc. Model No. RD-4A-RR Vandal-Proof aluminum roof drain and under deck clamp. Drain is to be completed with Furco Connection. Outlet size shall be verified on site by the Roofing Contractor.

4.11 Framing Lumber

4.11.1 Framing lumber on top of roof area shall be Spruce conforming to CSA 0322-1976 and CSA 080-M1983. Size as shown on the project drawings. Grade SPF No. 2 or better.

4.0 PRODUCTS – ROOF AREA 'P'

Partial Roof Replacement
for
Ursuline College Chatham Catholic Secondary School
Project № 725-CP1831

4.12 Plywood

4.12.1 Exterior grade fir to CSA 0121 or CSA 0151 to the thickness indicated on the project drawings.

4.13 Metal Flashings

4.13.1 Metal Flashings shall be 24ga Colorite 8000 Series pre-finished steel (both sides) as manufactured by Westeel Roscoe, Steelcolour 8000 Series or Owner approved equal, formed to comply with field conditions. The colour is to be brown as selected by the Owner from the manufacturer's standard colours. A one meter 'test bend' for each general metal flashing condition shall be completed and presented to the Owner's Representative for approval prior to general fabrication.

4.14 Painting

- 4.14.1 All existing gas lines, pipe stacks, exhaust fan hoods shall be cleaned and scraped prior to being repainted.
- 4.14.2 Clean and prime with alkyd metal primer before applying two coats of enamel paint. The colour shall match existing colour.

4.15 Concrete Pads

4.15.1 Precast Concrete Pads shall be 24 inch by 24 inch by 2 inch thick for additional walkway, etc. as show on Roof Plans. Pads shall be placed on a 20 inch by 20 inch by 1 inch thick section of Rigid Type 4 Extruded Polystyrene Insulation.

10 NEW CONCRETE PADS ARE REQUIRED IN TOTAL

5.0 EXECUTION - ROOF AREA 'P'

Partial Roof Replacement
for
Ursuline College Chatham Catholic Secondary School
Project № 725-CP1831

75 MIL REINFORCED EPDM MECHANICALLY FASTENED ROOF SYSTEM

5.1 General

- 5.1.1 Comply with the manufacturer's published instructions for the installation of the membrane roofing system including proper substrate preparation, jobsite considerations and weather restrictions.
- 5.1.2 Position sheets to accommodate contours of the roof deck and shingle splices to avoid bucking water.

5.2 Installation of Vapour Retarder

- 5.2.1 Install vapour retarder only to clean, dry surfaces.
- 5.2.2 Vapour retarder is required to be enveloped over rigid insulation.
- 5.2.3 Vapour retarder is required to be laid directly on top of the metal roof deck.
- 5.2.4 Overlap on the side laps shall be no less than three (3) inches wide and end laps shall be at least six (6) inches wide with staggered joints.
- 5.2.5 A bead of sealant is required on all overlaps when 10 mil polyethelene is applied.

5.3 Insulation Placement and Attachment

- 5.3.1 Install insulation or membrane underlayment over the substrate with boards butted tightly together with no joints or gaps greater than 1/8 inch. Stagger joints both horizontally and vertically if multiple layers are provided.
- 5.3.2 Secure insulation to the substrate with the required mechanical fasteners in accordance with the manufacturer's specifications. (no less than 4 per board) (1st layer)
- 5.3.3 Install second layer of rigid insulation with Fast 100 Adhesive to the lower rigid insulation as indicated. On all insulation surfaces intended for board coverage, apply continuous stripes of 13 to 19mm (1/2" to 3/4") on 150mm (6") centers for twelve (12) feet around roof perimeter and 200mm (8") centers for the field of the roof.
- 5.3.4 Firmly set the second layer of rigid insulation boards into the strips of the Fast 100 Adhesive. All boards must be evenly and tightly butted together in stagger fashion.
- 5.3.5 Apply only as many boards as can be covered in the same day.

5.4 Membrane Placement and Attachment

- 5.4.1 Unroll and position membrane without stretching. Allow the membrane to relax for approximately 1/2 hour prior to attachment. Provide and secure both perimeter and field membrane sheets in accordance with the manufacturer's most current specifications and details.
- 5.4.2 Secure the membrane (along the pre-printed blue line approximately 3" from the edge of the membrane sheet) with the required Sure-Seal Fastener and 2" Polymer Seam Plate (required for steel decks) or Seam Fastening Plate spaced a maximum of 12" on center. The minimum distance between the edge of the fastening plate and the edge of the membrane must be 2 inches.

5.0 EXECUTION - ROOF AREA 'P'

Partial Roof Replacement for Ursuline College Chatham Catholic Secondary School Project № 725-CP1831

- 5.4.3 Install adjoining membrane sheets in the same manner in accordance with the manufacturer's specifications.
- 5.4.4 Mechanically install fastener strip to all perimeter roof membrane and secure into the roof parapet with approved screw fasteners or RUSS (Reinforced Universal Securement Strip).
- 5.4.5 Bond roof membrane to the Reinforced Universal Securement Strip using splicing adhesive.

5.5 Membrane Splicing with SecurTape

- 5.5.1 Tape splices where fastening plates are located (along the length of the membrane) must utilize 6" wide SecurTape or FAT. Tape splices at end roll sections (along the width of the membrane without fastening plates) shall utilize 3" wide SecurTape.
- 5.5.2 Overlap adjacent sheets and mark a line approximately 1/4" to 1/2" from the top sheet edge.
- 5.5.3 Apply Sure-Seal HP-250 Primer to the splice area.
- 5.5.4 When Factory-Applied Tape (FAT) is not used, apply SecurTAPE in accordance with the manufacturer's specifications and roll the top sheet onto the mating surface.
- 5.5.5 Immediately roll the splice using positive pressure when using a 2" wide steel roller. Roll across the splice edge, not parallel to it. When using FAT, Carlisle's Stand-Up Seam Roller can be used to roll parallel to the splice edge.
- 5.5.6 All field splice seams are to be flashed in with 6"wide overlay Pressure Sensitive Flashing Membrane.
- 5.5.7 Lap sealant is required for all field splices. Feather the lap sealant with a specially performed tool so that the high point or the crown of the lap sealant is located over the edge of splice.

5.6 Flashing

- 5.6.1 Wall and curb flashing shall be cured EPDM membrane. Continue the deck membrane as wall flashing where practicable.
- 5.6.2 Follow manufacturer's typical flashing procedures for all wall, curb, and penetration flashing including metal edging/coping and roof drain applications.
- 5.6.3 Once the roof membrane is adhered to the securement strip, then bond the flashing membrane using bonding adhesive. Flashing membrane shall extend continuously up the entire height of the parapet over the parapet and down the exterior face as indicated on the enclosed drawings.

5.7 Installation of Metal Flashings

- 5.7.0 Cap flashings shall be jointed with a double S-type locked joint. Flashings shall be installed with continuous clips secured to the wood capping blocking at 12 inches on centre.
- 5.7.1 Flashings shall be fabricated to shapes on site with all necessary breaks for adequate expansion.

5.0 EXECUTION – ROOF AREA 'P'

Partial Roof Replacement for Ursuline College Chatham Catholic Secondary School Project № 725-CP1831

- 5.7.2 The inside face of the metal cap flashing between the S-locked joint is to be secured with three (3) fasteners matching the colour of the metal cap with neoprene washer between the head and inside face of the metal cap flashing.
- 5.7.3 All joints shall be sealed with approved sealant.
- 5.7.4 Counter flashings shall be installed at all reglets and curbs with at least three (3) inches below top of roof curb or reglet.

5.8 Walkways

- 5.8.1 Install walkways in those locations as designated on the project drawings.
- 5.8.2 Install one inch extruded polystyrene rigid insulation over top the single ply membrane as indicated on the project drawings.
- 5.8.3 Then install the concrete pavers as specified on top the rigid insulation as indicated on the roof plan.

5.9 Daily Seal

- 5.9.1 On phased roofing, when the completion of flashings and terminations is not achieved by the end of the work day, a daily seal must be performed to temporarily close the membrane to prevent water infiltration.
- 5.9.2 Complete an acceptable membrane seal in accordance with the manufacturer's requirements.

5.10 Clean Up

- 5.10.1 Perform daily clean-up to collect all wrappings, empty containers, paper, and other debris from the project site. Upon completion, all debris must be disposed of in a legally acceptable manner.
- 5.10.2 Prior to the manufacturer's inspection for warranty, the applicator must perform a pre-inspection to review all work and to verify all flashing has been completed as well as the application of all caulking.

6.0 PRODUCTS - ROOF AREA 'K'

Partial Roof Replacement
for
Ursuline College Chatham Catholic Secondary School
Project № 725-CP1831

6.1 Modified Bitumen Membrane

- 6.1.1 Modified Bitumen Sheets shall conform to CGSB 37-GP-56M "Membrane, Modified, Bituminous, Prefabricated and Reinforced for Roofing";Type 2, Class C, Grade 2 for Base Sheets and Type 1, Class A, Grade 2 for Cap Sheets.
- 6.1.2 The Contractor may bid on any Manufacturer's Systems specified for torching application of the base sheet and torching of the cap sheet for this roof area. The colour of the granular surface is to be selected by the Owner. Supply additional granules to be applied to bitumen outflows between membrane sheets.
- 6.1.3 Modified Bitumen Membrane Two-Ply System shall be as specified or approved equal and accepted by the Consultant and Owner.

a) Soprema

- i) Base Sheet (SOPRALENE 180 S/P 3.5 for Cap Sheet)
- ii) Self-Adhesive Membrane (NP 180 Tack Sheet)
- iii) Cap Sheet (NP250gT4) for flashing membrane.

6.2 Insulation Soprasmart Board 180

6.2.1 Soprasmart board 180 is a high performance high density support panel composed of SBS modified bitumen membrane with a non-woven polyester reinforcement, factory-laminated on asphaltic board (SOPRABOARD). The surface is covered with a thermo-fusible plastic film.

6.3 Primer

6.3.1 The primer shall consist of Elastocol Stick designed for use with self-adhered SBS modified bitumen base sheet flashing membrane. The risk of primer flare-up is eliminated when modified bitumen cap sheets are thermo-fused to the self-adhered base sheet flashing membranes.

6.4 Duotack

6.4.1 Duotack is a LOW-RISE two-part urethane adhesive to be used for the application of rigid insulation.

6.5 Rigid Insulation

6.5.1 Insulation shall be roof insulation which is rigid closed cell, Polyiso Foam Insulation, integrally laminated to fiber-reinforced paper facers, thermal resistance of insulation shall be R-20.5 (L.T.T.R.) (3.5 inch) for the main roof area, Resistance R-Value in accordance with ASTM C1289-11A. All insulation boards shall be 4 feet by 4 feet in size.

6.6 Tapered Insulation

6.6.1 The tapered insulation shall be faced Isocyanurate Boards conforming to CAN/CGSB-51.26-M86, meeting the requirements of ULC S126 Polyisocyanurate foam panels chemically bonded during the foaming process to facers on the top and bottom organic surfaces. Tapered panels shall not be less than 13m at any point of the roof to the slope indicated on the Roof Plan and Details.

6.0 PRODUCTS - ROOF AREA 'K'

Partial Roof Replacement
for
Ursuline College Chatham Catholic Secondary School
Project № 725-CP1831

6.7 Metal Flashings

6.7.1 Metal flashings shall be 24ga. Colorite 8000 Series pre-finished steel (both sides) as manufactured by Westeel Roscoe, Steelcolour 5000 Series or Owner approved equal, formed to comply with field conditions. The colour is to be selected by the Owner from the Manufacturer's standard colours. A one meter "test bend" for each general metal flashing condition shall be completed and presented to the Owner's Representative for approval prior to general fabrication.

6.8 Sealants

6.8.1 Caulking Sealants for metal flashing shall be one part silicone to conform to CGSB 19 GP 96. Sealants shall be manufactured by Canadian General Electric, Dow Corning or approved equal. The colour of the sealant shall be identical to the colour of the metal flashing; the Owner is to approve the colour before ordering the sealant. This sealant shall be applied to all metal flashing joints including the reglet.

6.9 Framing Lumber

6.9.1 Framing Lumber on top of roof area shall be SPRUCE conforming to CSA 0322-1976 and CSA 080-M1983; sizes shown on the Drawings. Grade SPF No. 2 or better.

6.10 Plywood

6.10.1 Exterior Grade "fir" to CSA 0121 or CSA 0151, ½" and ¾" thick, as detailed on Enclosed Drawings.

6.11 Rough Hardware and Nails

6.11.1 The Roofing Contractor shall supply all rough hardware where required. Nails, spikes, screws, bolts, etc. shall be of sufficient size and type to rigidly secure all members into place. All nails shall be hot dip galvanized.

7.0 EXECUTION – ROOF AREA 'K'

Partial Roof Replacement
for
Ursuline College Chatham Catholic Secondary School
Project № 725-CP1831

7.1 Tear-Off

- 7.1.1 Prior to the start of installation, the roofing Contractor shall examine all roof areas included in this Specification. The Roofing Contractor shall notify the Consultant of any unacceptable conditions.
- 7.1.2 These conditions include, but are not limited to, uneven deck surfaces, improperly installed curbs and nailers, surfaces with fins or sharp projections, and surfaces contaminated with incompatible materials. Work shall not begin until these conditions have been corrected. Protect membrane in high traffic areas, work by other trades, application of gravel, etc.

7.2 INSTALLATION – Two Ply Modified Bitumen Membrane Roof System

- 7.2.1 Install all carpentry items such as curb extensions, wood blocking at roof perimeters, etc. as detailed on the Drawings. All wood members which are to be anchored to masonry construction shall be permanently fastened into place. Do not use fasteners which will cause spalling, cracking or deformation of fastened materials.
- 7.2.2 Apply roofing materials over clean and dry surfaces in accordance with the Manufacturer's Recommendations. The re-roofing operations shall be performed on a continuous basis as weather conditions allow.
- 7.2.3 Install all new wood blocking and plywood as detailed on the applicable details.

7.2.4 Installation of Rigid Insulation Boards

.1 Install boards with Duotack Adhesive to the vapour retarder. On all insulation surfaces intended for board coverage apply beads of 20mm (3/4") wide on 150 mm (6") centers for eight (8) feet around roof perimeter and 200 mm (8") centers for the field of the roof..

7.2.5 Installation of Soprasmart Board

- .1 Install Smart Boards with Duotack Adhesive to the rigid insulation as indicated. On all insulation surfaces intended for board coverage, apply continuous strips of 13 to 19 mm (½ to ¾ inch) on 150 mm (6") centers for eight (8) feet around roof perimeter and 200 mm (8") centers for the field of the roof.
- .2 Firmly set the Smart Boards, into the strips of Duotack Adhesive. All boards must be evenly and tightly butted together in soldier fashion.
- .3 Apply only as many boards as can be covered in the same day.
- .4 Install Sopralap cover strips across the end laps on the panels by heat-welded with a propane torch.

7.2.6 Installation of Metal Flashings

.1 Cap flashings shall be jointed with a double S-type locked joint. Flashings shall be installed with continuous clips secured to wood capping blocking at 12 inches o.c.

7.0 EXECUTION – ROOF AREA 'K'

Partial Roof Replacement for Ursuline College Chatham Catholic Secondary School Project № 725-CP1831

- .2 Flashings shall be fabricated to shapes on site with all necessary breaks for adequate expansion.
- .3 Gravel stop is required on both gable ends and drip edge on both eaves location.

7.2.7 Base Flashing Installation

.1 Once the metal drip edge and gravel stop are secured into place, then torch apply a twelve (12) inch wide strip over top the metal drip edge and gravel stop onto the Smartboard

7.2.8 Cap Sheet Installation

- .1 Begin application of the cap sheet parallel with the slope of the roof. Cap sheet shall be unrolled and care be taken to ensure proper alignment of the first roll.
- .2 Cap sheet shall be torched into place in accordance with the Recommendations of the Membrane Manufacturer, to the base sheet membrane.
- .3 The seams between the base sheet and cap sheet shall be staggered a minimum of 300 mm (12 inches).
- .4 Care should be taken to ensure heating is consistent across the width in order to avoid skips or voids. Bitumen should flow out from the lap 6mm (1/4") to ensure a tight seal.
- .5 All lap seams on the cap sheet are to be checked after membrane installation.

7.3 CLEAN-UP

7.3.1 Upon completion of the installation, the work shall be left clean and free of defects which might affect the durability or appearance of the building. Clean all roof surfaces, including adjacent roofs and grounds of all foreign matter resulting from this Roofing Project.

PARTIAL ROOF REPLACEMENT URSULINE COLLEGE CHATHAM CATHOLIC SECONDARY SCHOOL 85 GRAND AVENUE WEST CHATHAM ONTARIO N7L 1B6

PROJECT № 725 - CP1831

ENCLOSED DRAWINGS

UCC-B UCC-R1a UCC-R4 UCC-R4a	Existing and Proposed Roof System Key Roof Plan Enlarged Roof Plan – Area 'P' and 'K' (Roof Penetration and Dimensions) Enlarged Roof Plan – Area 'P' and 'K' (Tapered Insulation Layout)
UCC-D1 UCC-D2 UCC-D11 UCC-D12 UCC-D13 UCC-D14 UCC-D15 UCC-D16 UCC-D17 UCC-D18 UCC-D18	Roof Drain Detail – Typical Vent Pipe Stack Detail - Typical South Perimeter Wall – Area 'K' Gable End Detail – Area 'K' Perimeter Detail Between Area 'P' and 'K' Perimeter Detail Area 'K' (East End) South Perimeter Detail – Area 'P' Perimeter Wall Detail – Area 'P' Perimeter Wall Detail – Area 'P' New Platform Detail Beneath Roof Top Unit – Area 'P' Wall Ladder Detail – Leading to Area 'P' Roof Ladder Detail – Area 'P'

PARTIAL ROOF REPLACEMENT URSULINE COLLEGE CHATHAM CATHOLIC SECONDARY SCHOOL 85 GRAND AVENUE WEST CHATHAM ONTARIO N7L 1B6

PROJECT № 725 - CP1831

EXISTING ROOF SYSTEM

DESIGN ROOF SYSTEM


AREA 'K'


3.5" Standing Seam Metal Roof Panel


Two-Ply Modified Bitumen Membrane On Asphalt Core Protection Board On 3.5" (ISO) Rigid Insulation On Existing Standing Seam Metal Roof Panel

AREA 'P'

Single Ply EPDM Membrane On 2" Rigid Insulation (ISO) On Metal Deck (N-S Direction) 75 Mil EPDM Reinforced Membrane
On Tapered (ISO) Rigid Insulation as Noted
On 2" (ISO) Rigid Insulation
On 2" (ISO) Rigid Insulation
On Vapour Retarder as Specified
On Existing Metal Deck (N-S Direction)

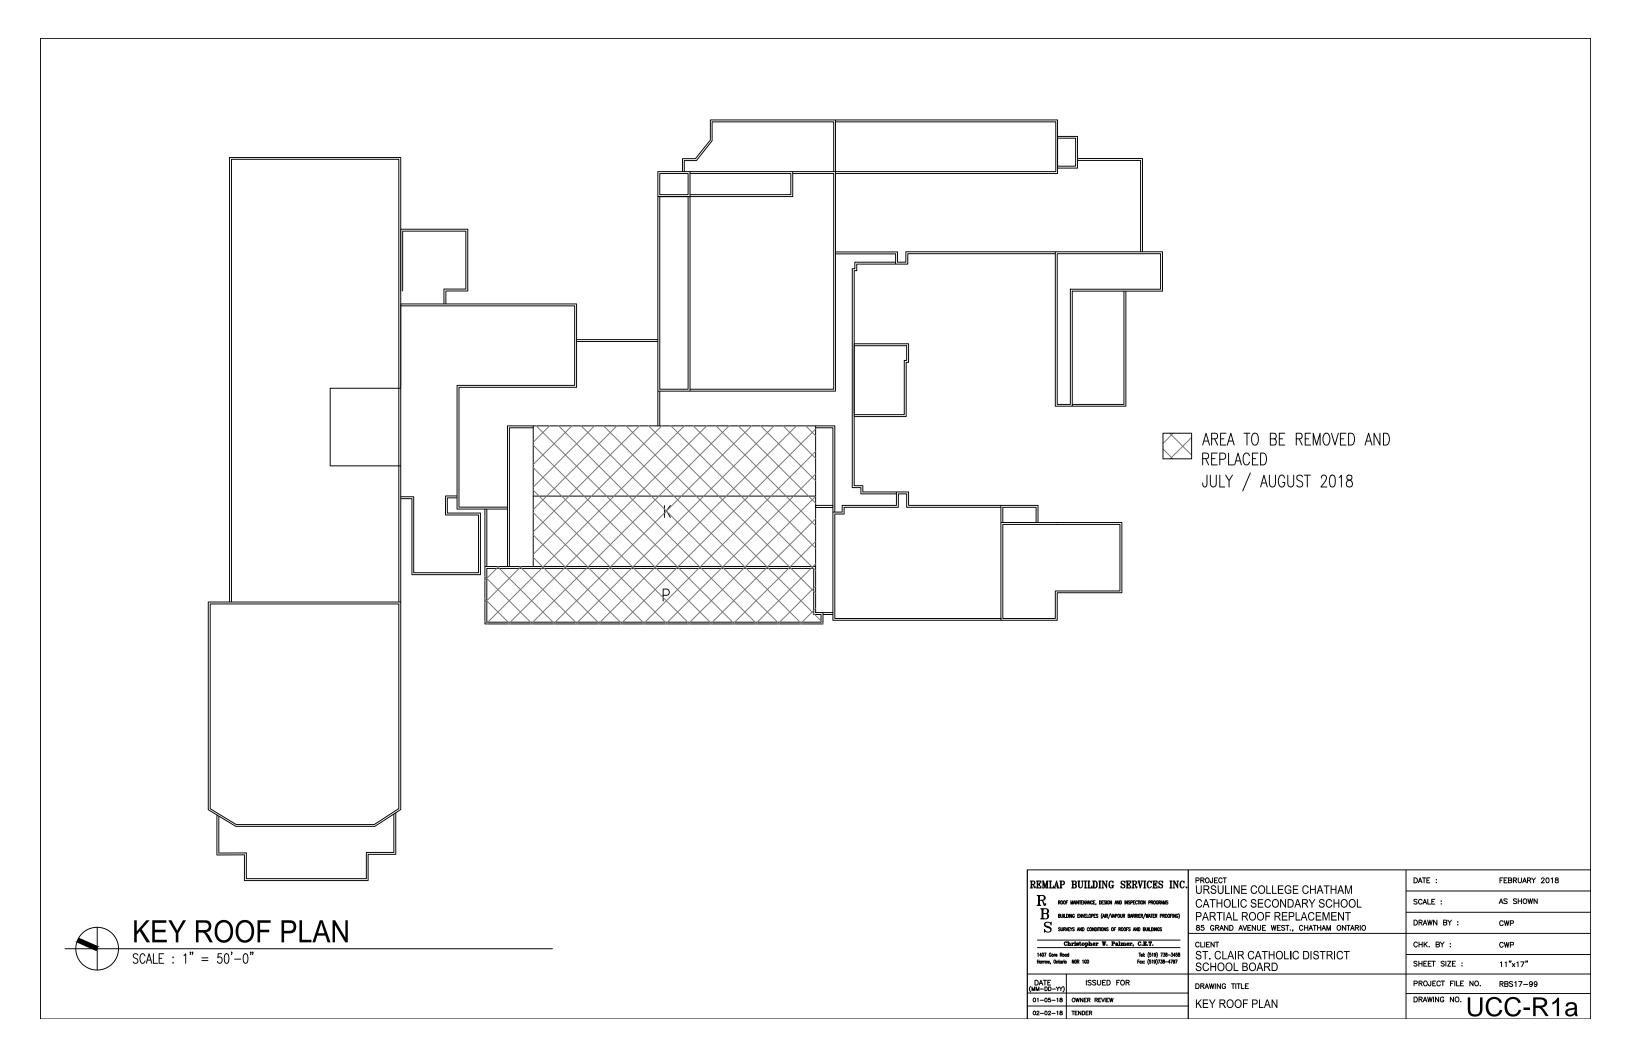

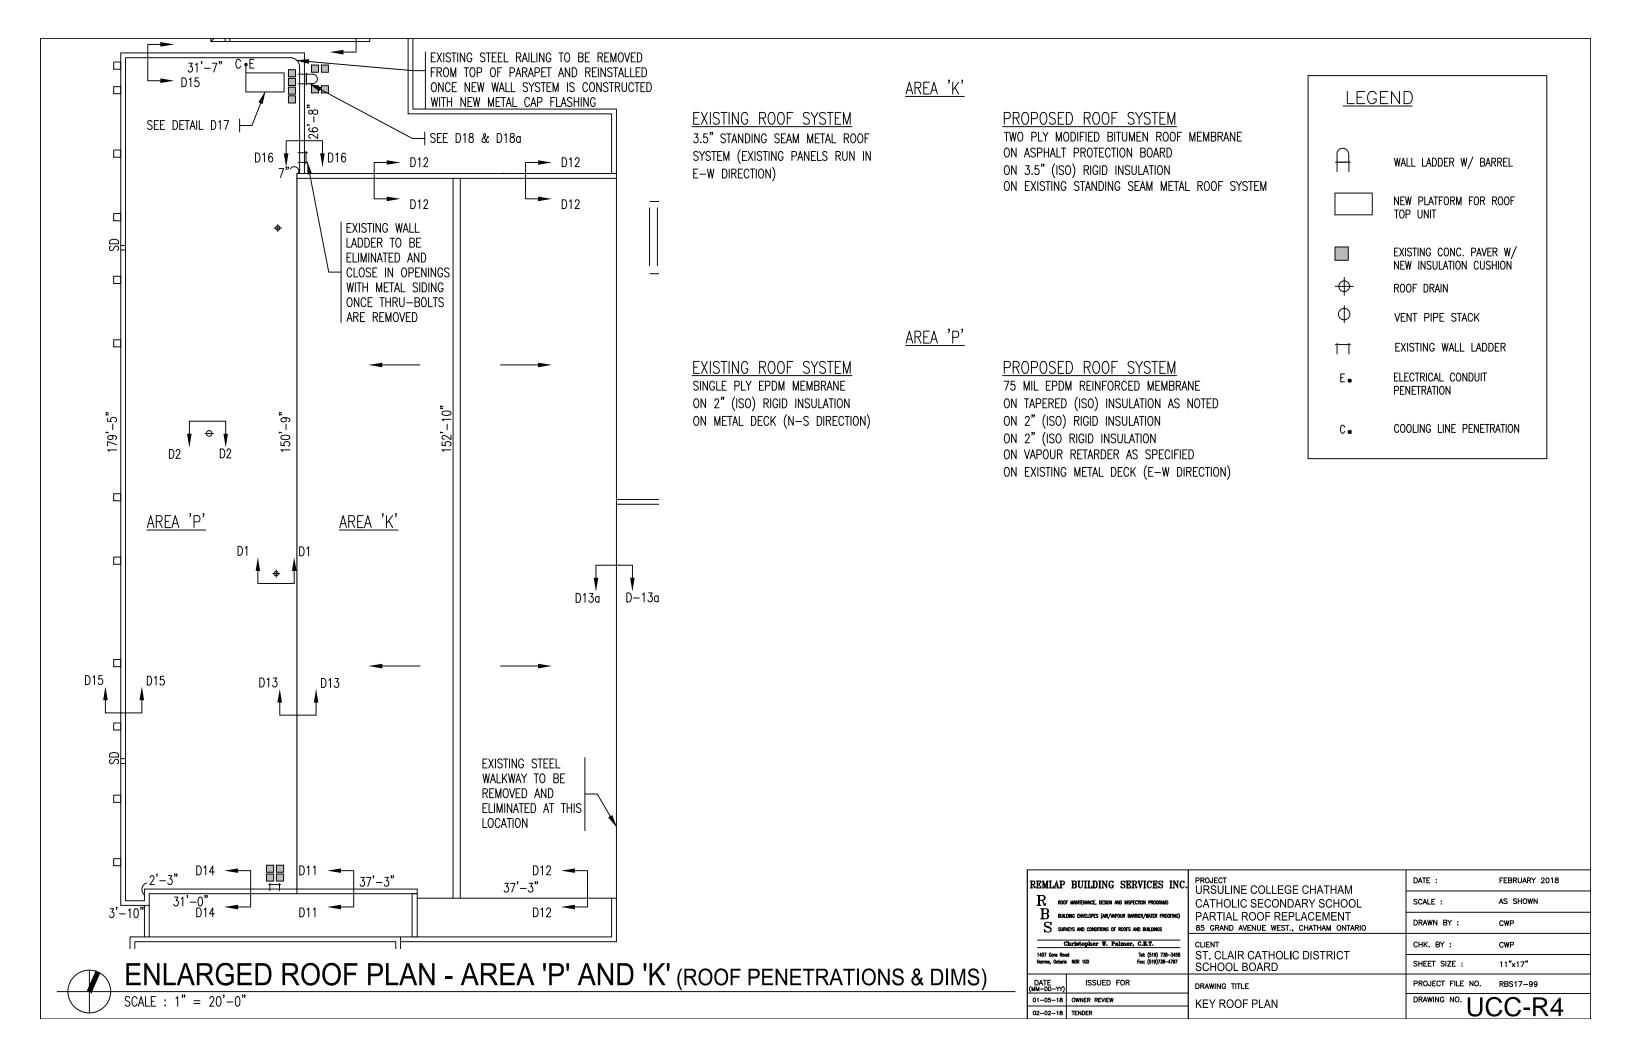

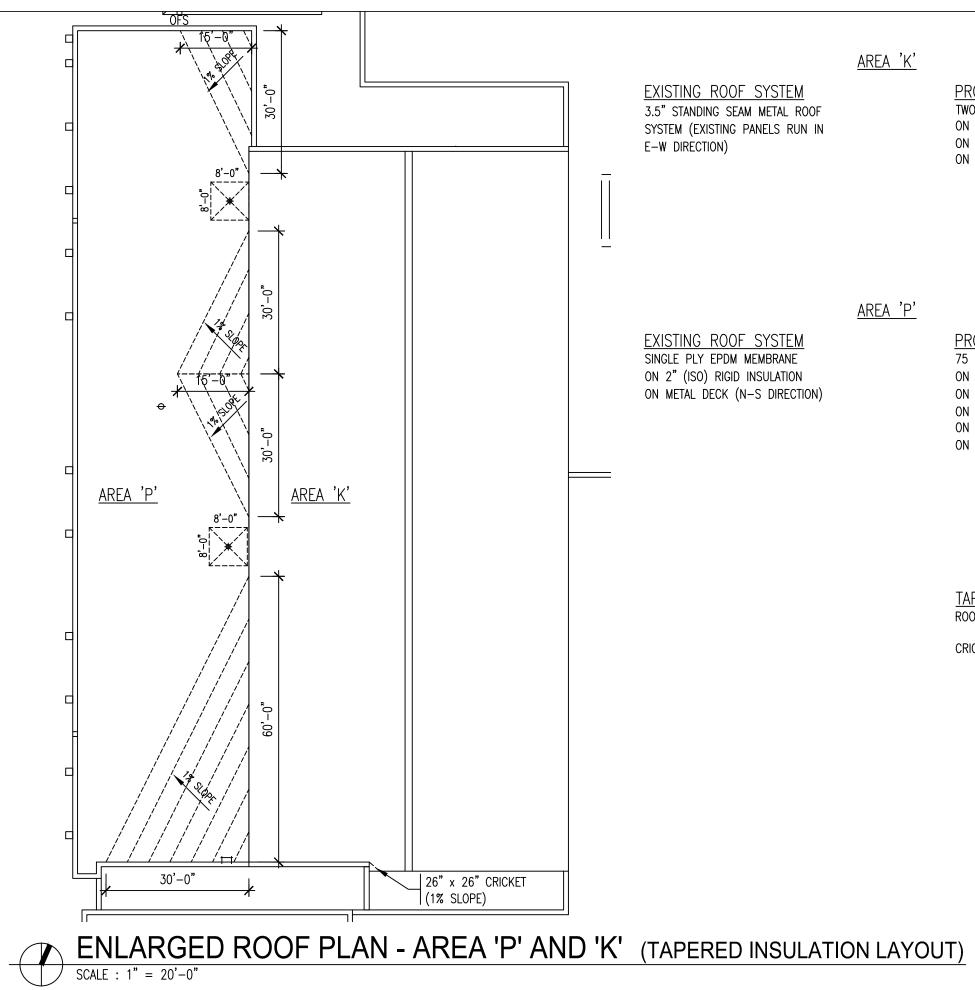

PROPOSED ROOF SYSTEM

TWO PLY MODIFIED BITUMEN ROOF MEMBRANE

ON ASPHALT PROTECTION BOARD ON 3.5" (ISO) RIGID INSULATION

ON EXISTING STANDING SEAM METAL ROOF SYSTEM

PROPOSED ROOF SYSTEM

75 MIL EPDM REINFORCED MEMBRANE

ON TAPERED (ISO) INSULATION AS NOTED

ON 2" (ISO) RIGID INSULATION

ON 2" (ISO RIGID INSULATION

ON VAPOUR RETARDER AS SPECIFIED


ON EXISTING METAL DECK (E-W DIRECTION)

TAPERED INSULATION

ROOF DRAIN - 2% SLOPE

CRICKETS - 1% SLOPE


REMLAP BUILDING SERVICES INC.	URSULINE COLLEGE CHATHAM	DATE :	FEBRUARY 2018
R ROOF MAINTENANCE, DESIGN AND INSPECTION PROGRAMS		SCALE :	AS SHOWN
B BUILDING ENVELOPES (AIR/VAPOUR BARRIER/WATER PROOFING) S SURVEYS AND CONDITIONS OF ROOFS AND BUILDINGS		DRAWN BY :	CWP
Christopher W. Palmer, C.E.T. 1407 Gore Road Tel: (519) 738-3458	CLIENT ST. CLAIR CATHOLIC DISTRICT SCHOOL BOARD	CHK. BY :	CWP
Harrow, Ontario NOR 1GO Fax: (519)738-4797		SHEET SIZE :	11"x17"
DATE (MM-DD-YY) ISSUED FOR	DRAWING TITLE	PROJECT FILE NO.	RBS17-99
01-05-18 OWNER REVIEW	TAPERED INSULATION LAYOUT	DRAWING NO. UCC-R4a	
02-02-18 TENDER	2.(25 !!!OSE !!!O!! E!!!OO!	U	JU-R4a

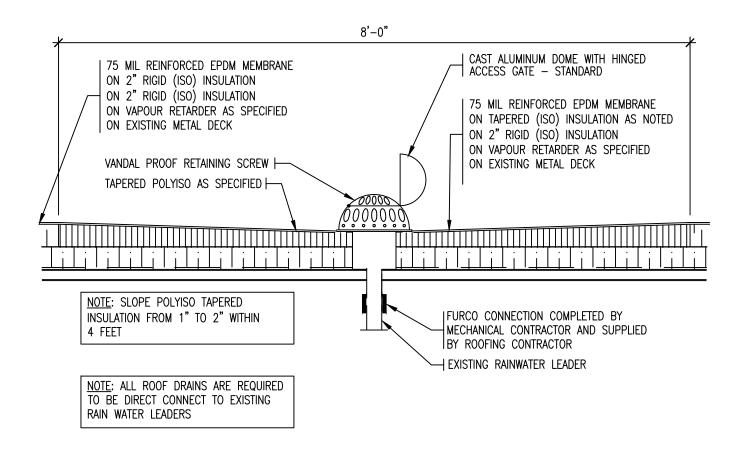

ROOF DRAIN DETAIL - TYPICAL

SCALE : 1'' = 1'-0''

REMLAP BUILDING SERVICES II	IC. PROJECT URSULINE COLLEGE CHATHAM	DATE :	FEBRUARY 2018
R наст минтания, кезан на начестан главная	CATHOLIC SECONDARY SCHOOL	SCALE :	N.T.S.
S sinces no consists of noor no necessary	EMERGENCY ROOF REPLACEMENT 85 GRAND AVENUE WEST., CHATHAM ONTARIO	DRAWN BY :	CWP
Christopher W. Falmer, C.E.T.	CLIENT ST. CLAIR CATHOLIC DISTRICT SCHOOL BOARD	CHK. BY :	CWP
Harrow, Octobe MDR 100 Fee: (\$10)730-171		SHEET SIZE :	8.1/2"x11"
DATE ISSUED FOR	DRAWING TITLE	PROJECT FILE NO.	RBS17-99
01-05-18 OWNER REVIEW	ROOF DETAIL	DRAWING NO.	20.04
02-02-18 TENDER		I UC	JC-D1

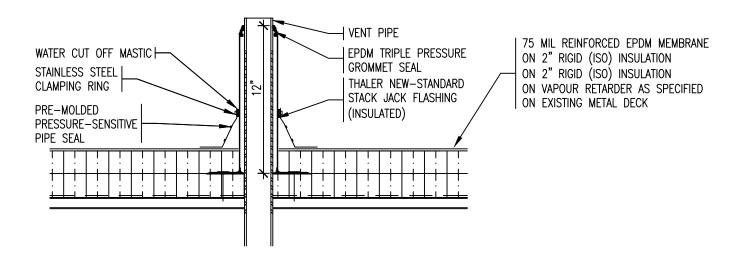


NOTE:

IF EXISTING VENT STACK IS NOT HIGHER THAN THE NEW SJ-38, THE CONTRACTOR IS REQUIRED TO EXTEND A MINIMUM OF 3" ABOVE EPDM GROMMET SEAL


VENT PIPE STACK DETAIL - TYPICAL

REMLAP	BUILDING SERVICES INC.	PROJECT URSULINE COLLEGE CHATHAM	DATE :	FEBRUARY 2018
1 7	F WHITCHICE, DESIGN AND HISPECTEN PROGRAMS	CATHOLIC SECONDARY SCHOOL EMERGENCY ROOF REPLACEMENT 55 GRAND AVENUE WEST., CHATHAM ONTARIO	SCALE :	N.T.S.
1 7	LONG EMELOTES (MI/MFOUR BANKER/MATER PROOFING) MEIS AND COMMISS OF NOOTS AND BALLONIS		DRAWN BY :	CWP
1407 Sera Ba	Christopher W. Falmer, C.E.T.	CLIENT ST. CLAIR CATHOLIC DISTRICT SCHOOL BOARD	CHK. BY :	CWP
Herroe, Oxfori			SHEET SIZE :	8.1/2"x11"
DATE (MM-DD-YY)	ISSUED FOR	DRAWING TITLE	PROJECT FILE NO.	RBS17-99
01-05-18	OWNER REVIEW	ROOF DETAIL	DRAWING NO.	
02-02-18	TENDER		i UC	:C-D2

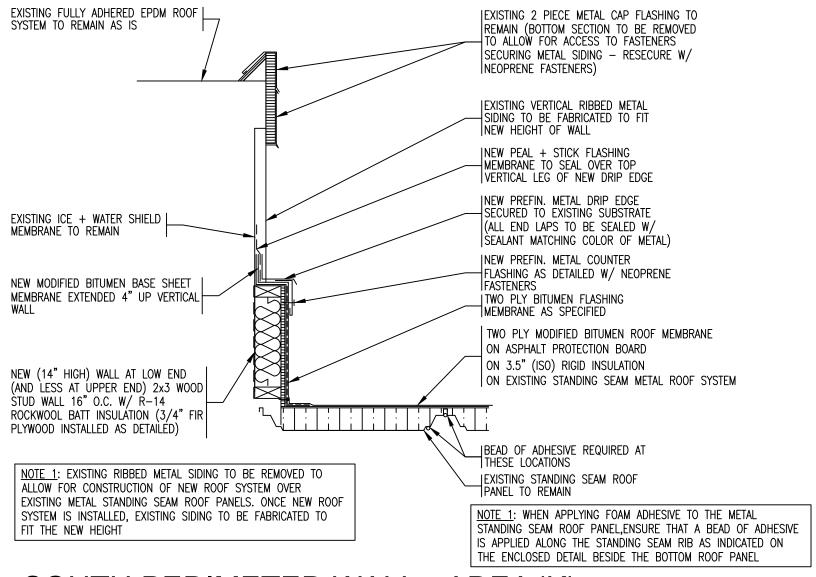


SOUTH PERIMETER WALL - AREA 'K'

REMLAP	BUILDING SERVICES INC.	PROJECT URSULINE COLLEGE CHATHAM	DATE :	FEBRUARY 2018
R ∞	OF INHITIMACE, DESIGN AND INSPECTION PROGRAMS	CATHOLIC SECONDARY SCHOOL	SCALE :	N.T.S.
1 7~	LONG EMELOPES (MI/MPGUR MANNEN/MANER PROGRAM) THENS AND CONSTRUCTS OF NEODY AND MALLONIS	PARTIAL ROOF REPLACEMENT 85 GRAND AVENUE WEST., CHATHAM ONTARIO	DRAWN BY :	CWP
Christopher W. Falmer, C.E.T.		CLIENT ST. CLAIR CATHOLIC DISTRICT	CHK. BY :	CWP
Harris, Orland		SCHOOL BOARD	SHEET SIZE :	8.1/2"x11"
DATE (MM-DD-YY)	ISSUED FOR	DRAWING TITLE	PROJECT FILE NO.	RBS17-99
01-05-18	OWNER REVIEW	ROOF DETAIL	DRAWING NO.	0.044
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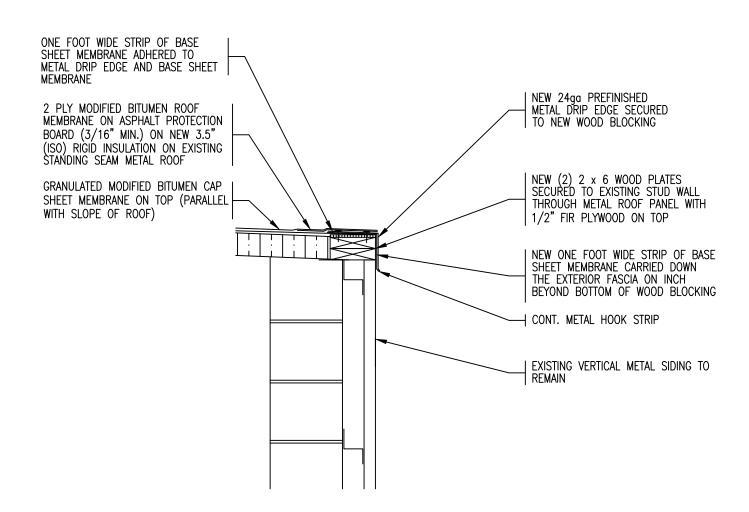
GABLE END DETAIL - AREA 'K'

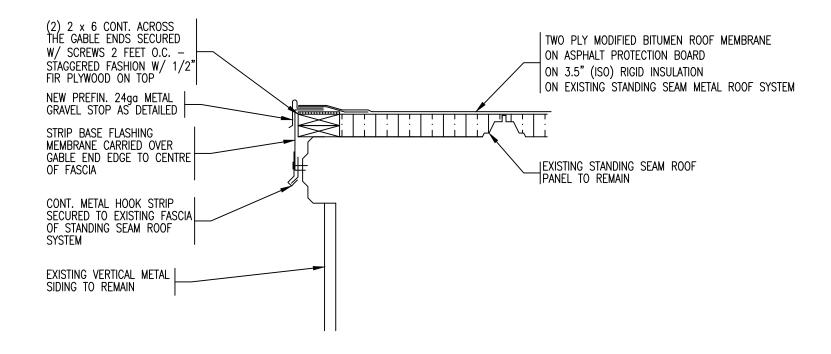REMLAP	BUILDING SERVICES INC.	PROJECT URSULINE COLLEGE CHATHAM	DATE :	FEBRUARY 2018
		CATHOLIC SECONDARY SCHOOL PARTIAL ROOF REPLACEMENT 85 GRAND AVENUE WEST., CHATHAM ONTARIO	SCALE :	N.T.S.
1 70	LOUIS EMELOPES (MI/MFOUR BANNER/MINER PROCESSIS) THEIS AND COMMINIS OF RESTS AND MILLSHIPS		DRAWN BY :	CWP
1407 Sees 81	Christopher W. Falmer, C.E.T.	CLIENT ST. CLAIR CATHOLIC DISTRICT SCHOOL BOARD	CHK. BY :	CWP
Harriso, Order			SHEET SIZE :	8.1/2"x11"
DATE (MM-DD-YY)	ISSUED FOR	DRAWING TITLE	PROJECT FILE NO.	RBS17-99
01-05-18	OWNER REVIEW	ROOF DETAIL	DRAWING NO.	0.040
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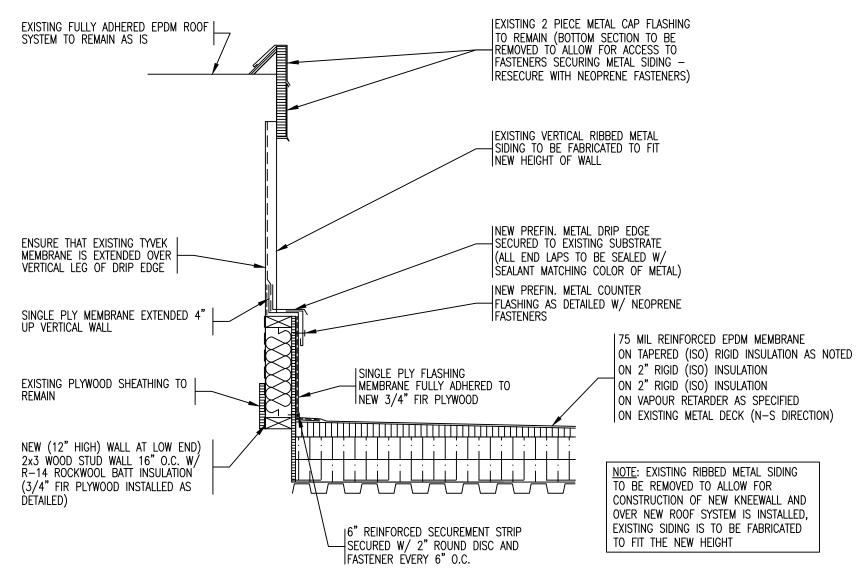
PERIMETER DETAIL BETWEEN AREA 'P' + 'K'

REMLAP	REMIAP BUILDING SERVICES INC.	PROJECT URSULINE COLLEGE CHATHAM CATHOLIC SECONDARY SCHOOL PARTIAL ROOF REPLACEMENT 85 GRAND ANDINE WEST., CHATHAM ONTARIO	DATE :	FEBRUARY 2018
- Trick			SCALE :	N.T.S.
	LONG EMELOTES (MI/MFOUR BANKER/MATER PROOFING) MEIS AND COMMISS OF NOOTS AND BALLONIS		DRAWN BY :	CWP
1607 Sees Dec	Christopher W. Falmer, C.E.T.	ST. CLAIR CATHOLIC DISTRICT SCHOOL BOARD	CHK. BY :	CWP
Harma, Ortok			SHEET SIZE :	8.1/2"x11"
DATE (MM-DD-YY)	ISSUED FOR	DRAWING TITLE ROOF DETAIL	PROJECT FILE NO.	RBS17-99
01-05-18	OWNER REVIEW		DRAWING NO.	C-D13

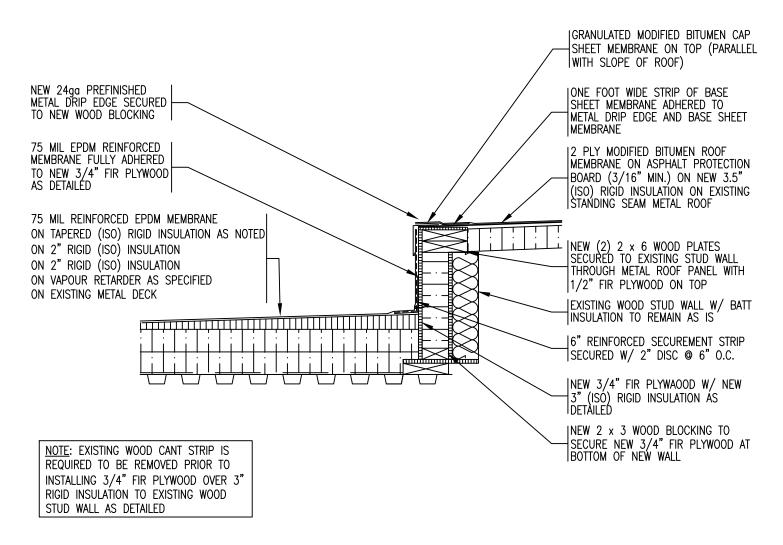


PERIMETER DETAIL AREA 'K' (EAST END)

REMLAP BUILDING SERVICES INC.	PROJECT URSULINE COLLEGE CHATHAM	DATE :	FEBRUARY 2018
R него инстанса, сезан на начестан масаная	CATHOLIC SECONDARY SCHOOL PARTIAL ROOF REPLACEMENT 85 GRAND AVENUE WEST., CHATHAM ONTARIO	SCALE :	N.T.S.
B succes no constants or recers no success		DRAWN BY :	CWP
Christopher W. Falmer, C.E.T.	CLIENT ST. CLAIR CATHOLIC DISTRICT SCHOOL BOARD	CHK. BY :	CWP
1607 Gare Read Tel: (018) 738-3600 Harron, Catalin MSR 100 Fac: (018)739-4787		SHEET SIZE :	8.1/2"x11"
DATE (MM-00-YY) ISSUED FOR	DRAWING TITLE	PROJECT FILE NO.	RBS17-99
01-05-18 OWNER REVIEW	ROOF DETAIL	DRAWING NO.	0.040
02-02-18 TENDER		l UC	C-D13a




SOUTH PERIMETER DETAIL - AREA 'P'

REMLAP BUILDING SERVICES INC.		PROJECT URSULINE COLLEGE CHATHAM	DATE :	FEBRUARY 2018
1 To 1	F WATCHICZ, JESUK MO HOPECTON PROGNAS	CATHOLIC SECONDARY SCHOOL PARTIAL ROOF REPLACEMENT 85 GRAND AVENUE WEST., CHATHAM ONTARIO	SCALE :	N.T.S.
1 ~	JANG EMELOPES (AN/APOUR BANKES/UNEER PROCESSE) METS AND COMMISSION OF ROOFS AND GALLANGS		DRAWN BY :	CWP
Christopher W. Falmer, C.S.T.		CLIENT ST. CLAIR CATHOLIC DISTRICT	CHK. BY :	CWP
Herroe, Caledo		SCHOOL BOARD	SHEET SIZE :	8.1/2"x11"
DATE (MM-DD-YY)	ISSUED FOR	DRAWING TITLE	PROJECT FILE NO.	RBS17-99
01-05-18	OWNER REVIEW	ROOF DETAIL	DRAWING NO. U.C.CD14	
02-02-18	TENDER			

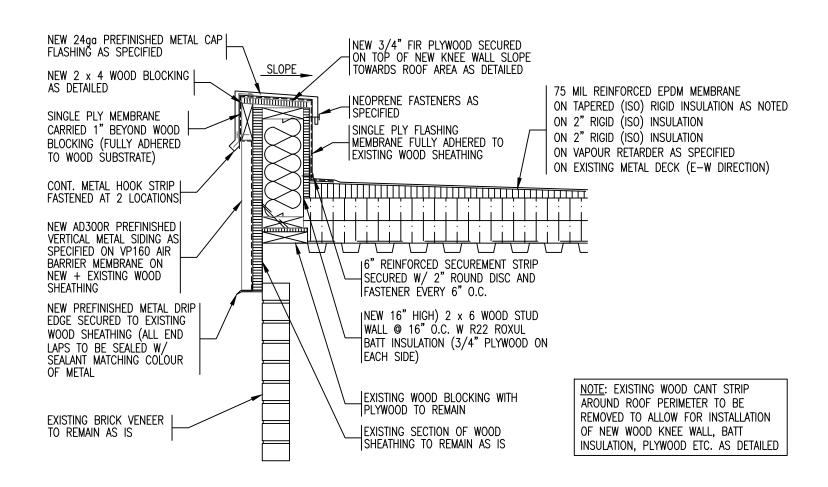


PERIMETER WALL DETAIL - AREA 'P'


REMLAP BUILDING SERVICES INC.		PROJECT URSULINE COLLEGE CHATHAM	DATE :	FEBRUARY 2018	
1 Ten	F WHITCHICE, JESSEN AND HISPECTICN PROGRAMS	CATHOLIC SECONDARY SCHOOL PARTIAL ROOF REPLACEMENT 85 GRAND AVENUE WEST., CHATHAM ONTARIO	SCALE :	N.T.S.	
1 ~	JANA EINELDTES (MI/MFOUR BONNES/MIER FRCCFINS) NEIS AND COMMICKS OF REOFS AND BULLBANS		DRAWN BY :	CWP	
Christopher W. Fulmer, C.E.T.		CLIENT ST. CLAIR CATHOLIC DISTRICT	CHK. BY :	CWP	
Herres, Caledo	ed Tet (\$11) 730-3450 b MSR 100 Fec (\$10)730-4767	SCHOOL BOARD	SHEET SIZE :	8.1/2"x11"	
DATE (MM-DD-YY)	ISSUED FOR	DRAWING TITLE	PROJECT FILE NO.	RBS17-99	
01-05-18	OWNER REVIEW	ROOF DETAIL	DRAWING NO.		
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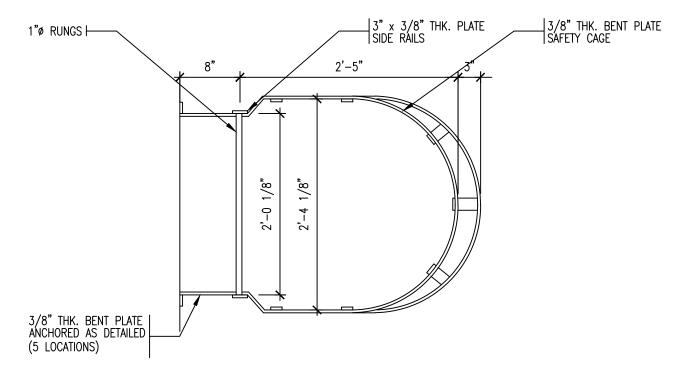


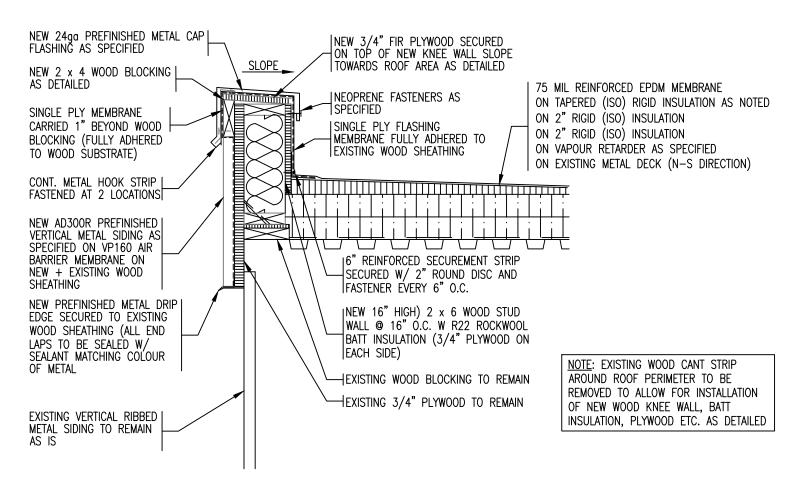PERIMETER WALL DETAIL - AREA 'P'

REMLAP BUILDING SERVICES INC.		PROJECT URSULINE COLLEGE CHATHAM	DATE :	FEBRUARY 2018
1 7	F WHITCHICE, DESIGN AND HISPECTEN PROGRAMS	CATHOLIC SECONDARY SCHOOL PARTIAL ROOF REPLACEMENT 85 GRAND AVENUE WEST., CHATHAM ONTARIO	SCALE :	N.T.S.
1 ~	LONG EMELOPES (MI/MFOUR BANKES/BASER PROCESS) METS AND COMMISSION OF ROOFS AND GALLANDS		DRAWN BY :	CWP
Christopher W. Fulmer, C.E.T.		CLIENT ST. CLAIR CATHOLIC DISTRICT	CHK. BY :	CWP
Herror, Orland	ed Tel: (\$11) 730-3650 b MR 100 Fee: (\$16)730-4767	SCHOOL BOARD	SHEET SIZE :	8.1/2"x11"
DATE (MM-DD-YY)	ISSUED FOR	DRAWING TITLE	PROJECT FILE NO.	RBS17-99
01-05-18	OWNER REVIEW	ROOF DETAIL	DRAWING NO. UCC-D16	
02-02-18	TENDER			



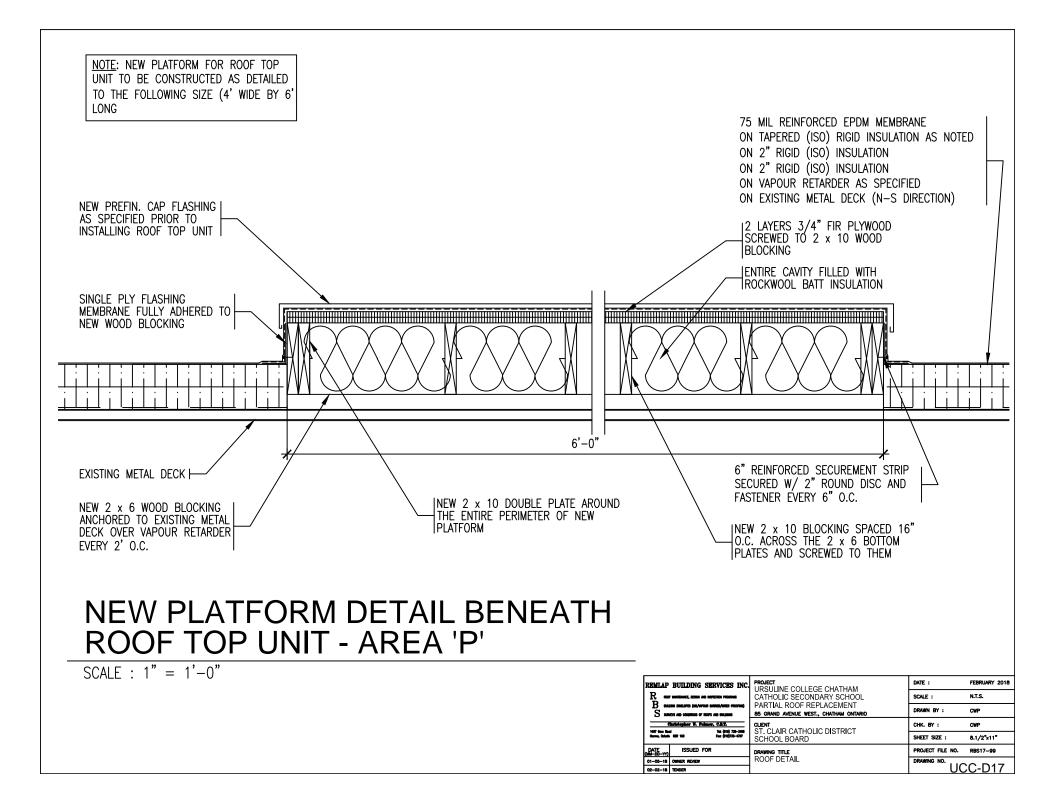

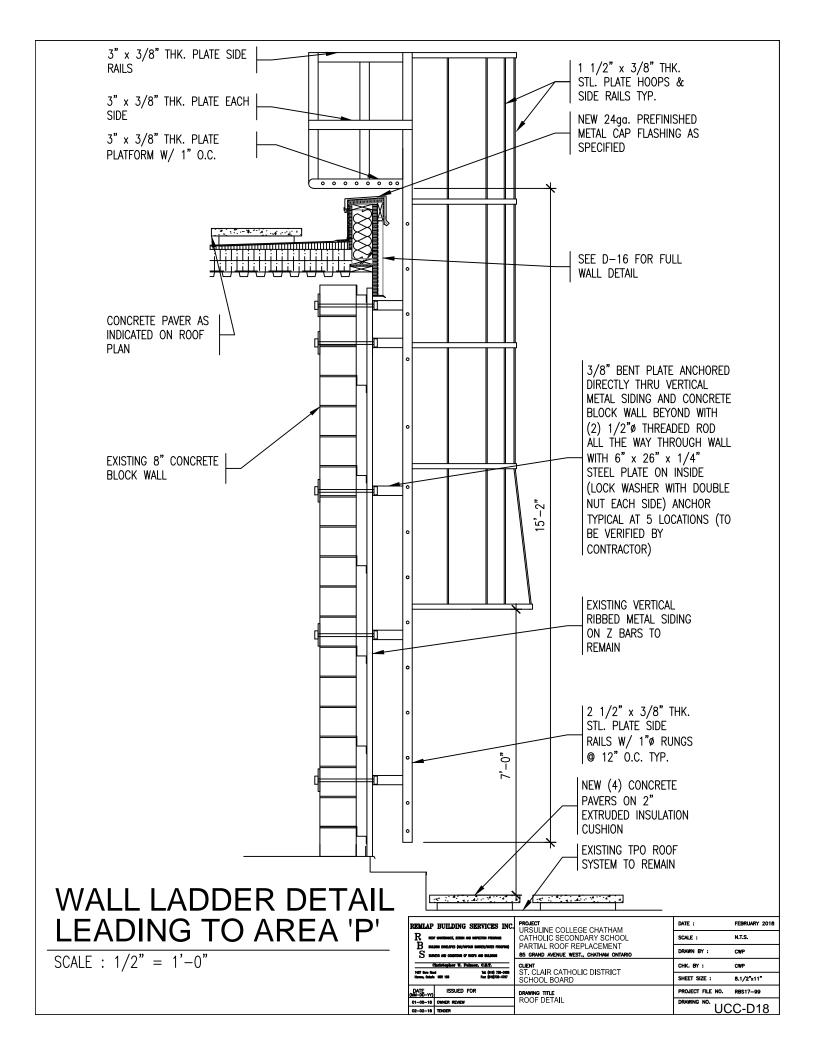

ROOF LADDER DETAIL PLAN - AREA 'P'

REMLAP BUILDING SERVICES INC.		PROJECT URSULINE COLLEGE CHATHAM	DATE :	FEBRUARY 2018
IR .	ROOF WHITEHACE, DESIGN AND HISPECTION PROGRAMS	CATHOLIC SECONDARY SCHOOL PARTIAL ROOF REPLACEMENT 85 GRAND AVENUE WEST., CHATHAM ONTARIO	SCALE :	N.T.S.
1 ~	BULDING EMELOPES (AN/APOUR BARREN/BREE PROOFIN) SUMMES AND COMMERCES OF ROOFS AND BALDANS		DRAWN BY :	CWP
Christopher W. Felimer, C.E.T.		CLIENT ST. CLAIR CATHOLIC DISTRICT	CHK. BY :	CWP
	facts 100 Fact (\$10)739-4707	SCHOOL BOARD	SHEET SIZE :	8.1/2"x11"
DATE (MM-DD-Y	ISSUED FOR	DRAWING TITLE	PROJECT FILE NO.	RBS17-99
01-05-1	18 OWNER REVIEW	ROOF DETAIL	DRAWING NO.	O D40-
02-02-1	TENNED		1 110	:C-D18a